



By: RML, Inc. 22, 2018, 2:55pm
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SITE PLAN (FOR REFERENCE ONLY)

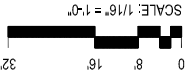

- GENERAL NOTES:**
1. ALL CONSTRUCTION OPERATIONS SHALL MINIMIZE DAMAGE TO THE EXISTING SITE AND UNDERGROUND IMPROVEMENTS.
 2. ALL EXISTING SITE IMPROVEMENTS DAMAGED BY CONSTRUCTION OPERATIONS SHALL BE REPAIRED TO EXISTING CONDITIONS AS PART OF THIS CONTRACT.
 3. CONTRACTOR SHALL BE FAMILIAR WITH ALL EXISTING UTILITIES AND BE RESPONSIBLE FOR PROTECTING THE SAME.

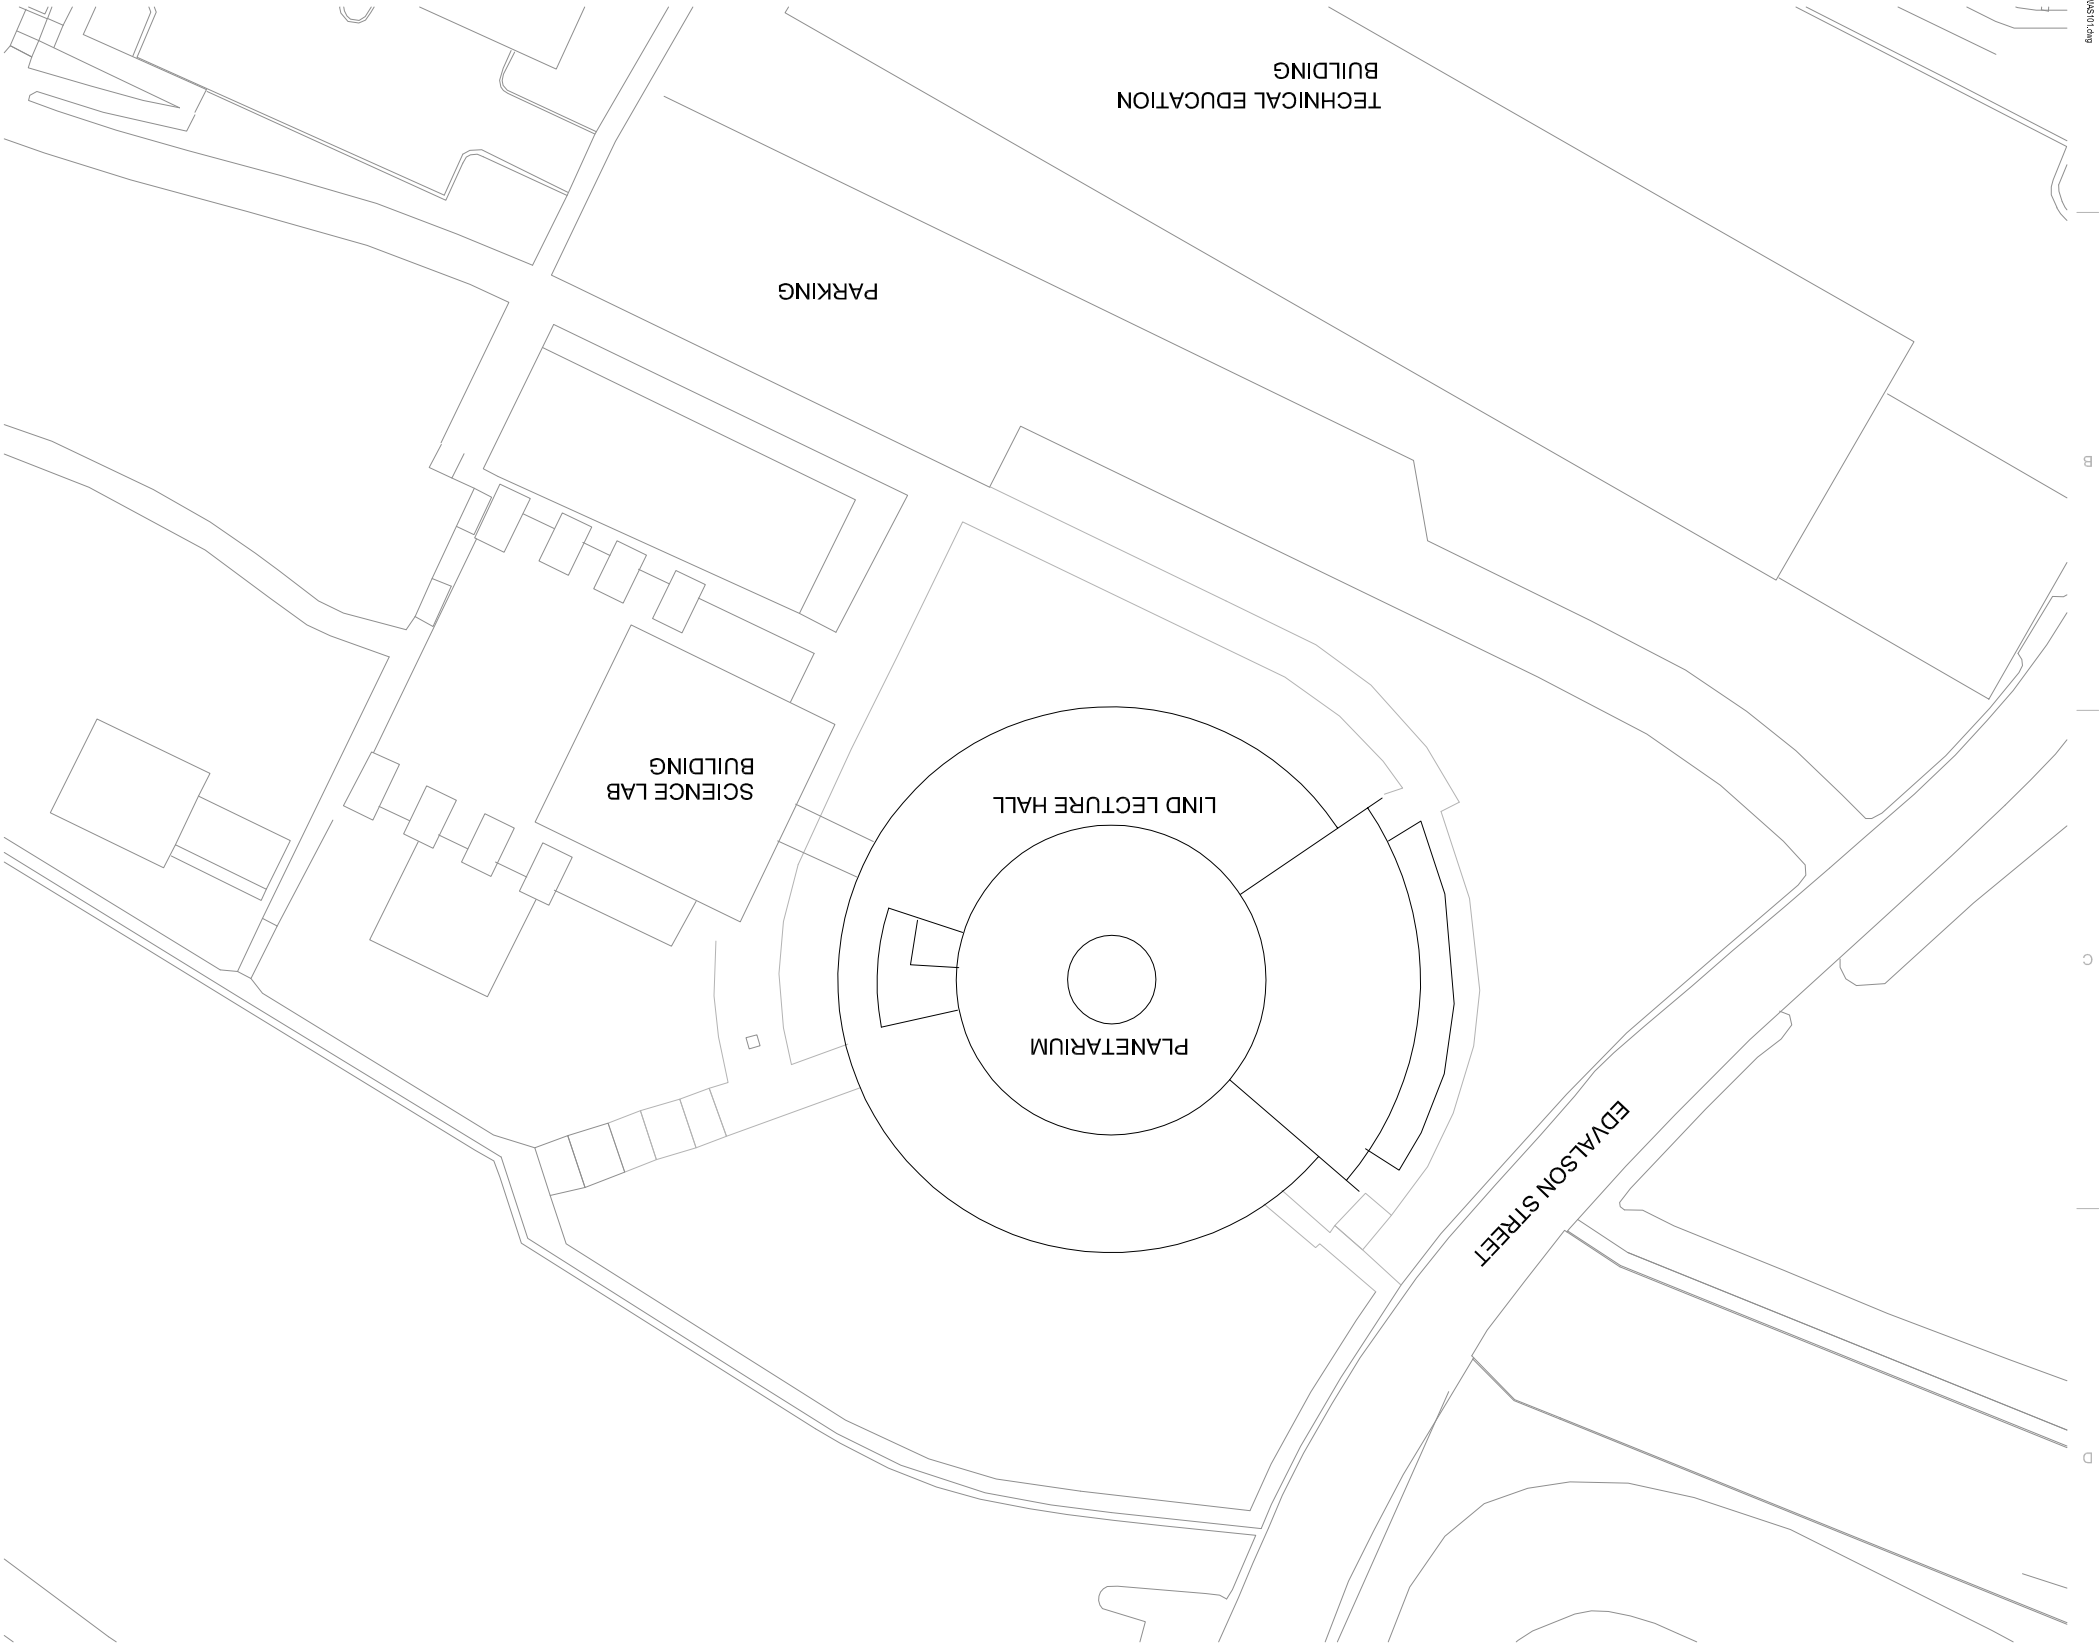

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UTAH STATE DIVISION OF
FACILITIES CONSTRUCTION & MANAGEMENT
DFCM PROJECT NO. 04040810

DATE: 04/18/2018
DRAWN BY: MJD
CHECKED BY: MJD
PROJECT NO. 2006605

REVISIONS:

NO.	DATE	DESCRIPTION

REVISIONS:

NO.	DATE	DESCRIPTION

SITE PLAN


AS101

DEMO & ABATEMENT SET


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GROUND FLOOR DEMO PLAN



CADAVER LAB ROOM 020 CEILING DEMO PLAN

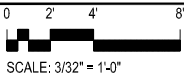

DEMOLITION GENERAL NOTES

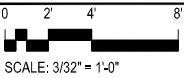
- WHERE NOTED, REMOVE ALL EXISTING FLOORING MATERIALS, INCLUDING GROUT BEDS AND ADHESIVE, TO EXISTING STRUCTURAL TOPPING OR SLAB ON GRADE.
- ALL DEMOLISHED OR REMOVED EXISTING MATERIAL SHALL BE LEGALLY DISPOSED OF BY THE CONTRACTOR, UNLESS NOTED OTHERWISE.
- OWNER SALVAGED ITEMS THAT WILL BE REMOVED FROM THE BUILDING PRIOR TO START OF DEMOLITION INCLUDE:
 - PLUMBING FLUSH VALVES, FAUCETS AND ELECTRIC WATER COOLERS,
 - TOILET ACCESSORIES,
- DEBRIS SHALL BE REMOVED FROM SITE DAILY OR AS DIRECTED BY THE VISU PROJECT MANAGER.
- CONTRACTOR SHALL REPAIR OR REPLACE EXISTING CONSTRUCTION DAMAGED BY DEMOLITION ACTIVATES. MATCH EXISTING SURFACE FINISH OR MATERIAL.
- CONTRACTOR IS RESPONSIBLE FOR LEAVING EXPOSED SURFACES AND SURFACES TO RECEIVE NEW FINISHES IN ACCEPTABLE CONDITION.
- REFER TO ABATEMENT SCOPE FOR AREAS CONTAINING ACM TO BE ABATED (NOT SHOWN IN ARCHITECTURAL DEMO DRAWINGS).
- REMOVE & SALVAGE ROOM SIGNS.
- DISCONNECT, SALVAGE & STORE ALL DEVICES AFFECTED BY DEMO OR ABATEMENT (ELEC, FIRE ALARMS, ETC.).
- PROTECT THE EXISTING PAINTED WALLS/MURALS ON THE SECOND FLOOR FROM DAMAGE. THESE WALLS TO BE COVERED WITH 6MIL "VISQUEEN" PRIOR TO DEMO/ABATEMENT WORK.

DEMOLITION PLAN LEGEND

- EXISTING TO REMAIN
- ITEMS TO BE REMOVED
- AREAS AFFECTED BY ARCHITECTURAL DEMO. OPERATIONS.

KEYNOTES

- REMOVE EXISTING SECTION OF WALL AS INDICATED
- REMOVE EXISTING CERAMIC TILE AND GROUT BED.
- REMOVE EXISTING DOOR AND FRAME AS INDICATED
- REMOVE EXISTING COUNTER.
- REMOVE EXISTING PLUMBING FIXTURE AS INDICATED, CAP PLUMBING LINES AT FLOOR OR WALL SURFACES.
- REMOVE EXISTING TOILET PARTITIONS AS INDICATED
- EXISTING CARPET, BASE, VAT (BELOW) AND ADHESIVE TO BE REMOVED
- EXISTING ELECTRIC WATER COOLER TO BE REMOVED BY OWNER
- REMOVE EXISTING CERAMIC TILE AND GROUT BED ON WALL SURFACE
- EXISTING DISPLAY TO REMAIN, PROTECT DURING DEMOLITION, RE: ASIDA01.
- EXISTING FLOOR MOSAIC TO BE REMOVED, REMOVE VAT BELOW.
- REMOVE EXISTING VAT (VAT MAY REMAIN BELOW DISPLAYS), AND THRESHOLD/TRANSITION STRIPS, RUBBER BASE, AND ALL ADHESIVES.
- REMOVE RUBBER BASE AND ADHESIVE.
- REMOVE TWO SECTIONS OF BLACKBOARD AND 24"x24" ACCESS DOOR.
- FIRE EXTINGUISHER & CABINET TO BE REMOVED
- SEE ABATEMENT SCOPE FOR WORK IN MECH. ROOM AND UTILITY CHASES & TUNNELS.
- REMOVE RAILING AND SUPPORTS, STARTING ONE SUPPORT BEYOND BOTTOM STAIR TREAD.

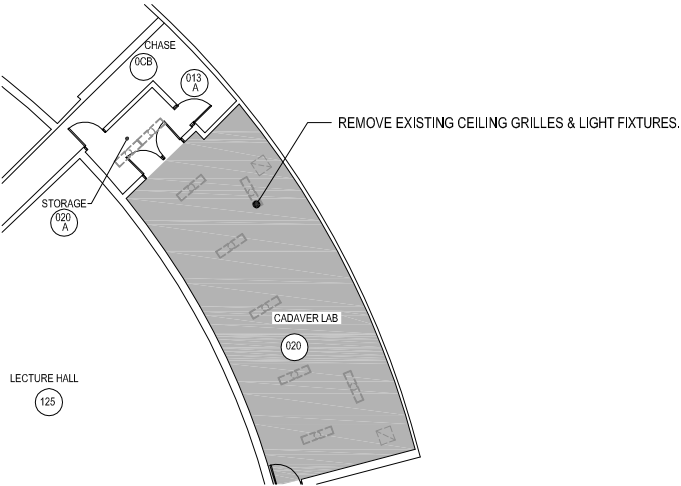

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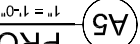
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DFCM PROJECT NO. 2005605	DRAWN BY: RAL	CHECKED BY: MG
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GROUND FLOOR
& CEILING DEMO
PLAN

DEMO & ABATEMENT SET

SHEET NUMBER

DAE100



Technical drawing of a display case. The drawing shows a top-down view of a rectangular case with a double-line border. Inside the case, there are two sets of three parallel diagonal lines, one in the upper left and one in the lower right. The text "DISPLAY CASE" is written vertically in the center. The text "ON ARTIFACT" is written vertically to the right of the center. The text "FRONT 244 PROVIDED AT TOP" is written vertically on the left side. The text "GLASS" is written vertically on the right side. The text "100 1/2 INCHES" is written horizontally at the bottom. The text "100 1/2 INCHES" is written horizontally at the top. The text "100 1/2 INCHES" is written horizontally on the right side. The text "100 1/2 INCHES" is written horizontally on the left side.

- DEMOLITION PLAN LEGEND

EXISTING TO REMAIN
ITEMS TO BE REMOVED
AREAS AFFECTED BY ARCHITECTURAL
DEMO OPERATIONS.

1. WHERE NOTED, REMOVE ALL EXISTING FOUNDATIONS.
2. STRUCTURAL TOPPING OR SLAB ON GRADE SHALL BE DEMOLISHED OR REMOVED EXISTING MATERIAL SHALL BE LEGALLY DISPOSED OF BY THE OWNER. WASTE NOTES SHALL BE REMOVED.
3. OWNER'S EXISTING PAVES SHALL WILL BE REMOVED FROM THE BUILDING PRIOR TO START OF DEMOLITION.
4. INCLUDE:
 - a. EXISTING PLUMBING FIXTURES AND
 - b. ELECTRICAL WATER COOLERS.
 - c. TOWER ACCESSORIES.
 - d. DEBRIS SHALL BE REMOVED FROM SITE DAILY OR AS DIRECTED BY THE WSO PROJECT EXISTING CONSTRUCTION MANAGEMENT BY DEMOLITION ACTIVITIES. MATCH EXISTING SURFACE FINISH OR MATERIAL.
5. CONTRACTOR IS RESPONSIBLE FOR REMOVING EXPOSED SURFACES AND SURFACES TO RECEIVE NEW FINISHES IN APPLICABLE CONDITION.
6. REFER TO ABUTMENT SCOPE FOR AREAS CONTAINING DAM BRIMMINGS.
7. REMOVE & SALVAGE ROAD SIGNS.
8. DISCONNECT & SALVAGE A STORE ALL DEVICES AFFECTED BY DEMO.
9. REMOVE OR REPAIR ALL WALLS ON THE SECOND FLOOR FROM DAMAGE. THESE WALLS TO BE COVERED WITH GML FLOOR/FLOOR FLOOR TO ENDOUSEMENT WORK.

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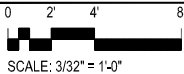
FIRST FLOOR DEMO PLAN

DEMO & ABATEMENT SET

DAE101

By: RAL, 11/22/2016, 1:25pm
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SECOND FLOOR REFLECTED CEILING DEMO PLAN



CEILING DEMOLITION GENERAL NOTES

1. PROVIDE TEMPORARY SUPPORT FOR LOOSE WIRING/CABLING & NON-SUPPORTED CONDUIT/PIPING DISCOVERED ABOVE THE EXISTING CEILING.
2. BRACE EXISTING PARTITION WALLS WITH METAL STUDS @ 8'-0" O.C., AFTER CEILING REMOVAL.

CEILING PLAN LEGEND

	2' x 4' ACOUSTICAL CEILING TILE SYSTEM
	AREA EFFECTED BY ARCHITECTURAL DEMO.
	2' x 4' RECESSED FLUORESCENT LIGHT FIXTURE
	1' x 4' SURFACE MOUNTED FIXTURE
	SUPPLY AIR DIFFUSER - SEE MECH.
	RETURN AIR/EXHAUST GRILLE

CEILING KEY NOTES

- 1 REMOVE EXISTING ACOUSTICAL SPRAY - ON COATING.
- 2 REMOVE EXISTING CEILING, INCLUDING FRAMING SYSTEM, LIGHT FIXTURES, DIFFUSERS, ACCESS DOORS, ETC.



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SECOND FLOOR CEILING DEMO PLAN


DEMO & ABATEMENT SET

SHEET NUMBER

DAC102

ACOUSTICAL INSULATION
MECHANICAL ROOM & AIR HANDLERS

THERMAL SYSTEM INSULATION
TSI JOINTS/FITTINGS (MUDDED)

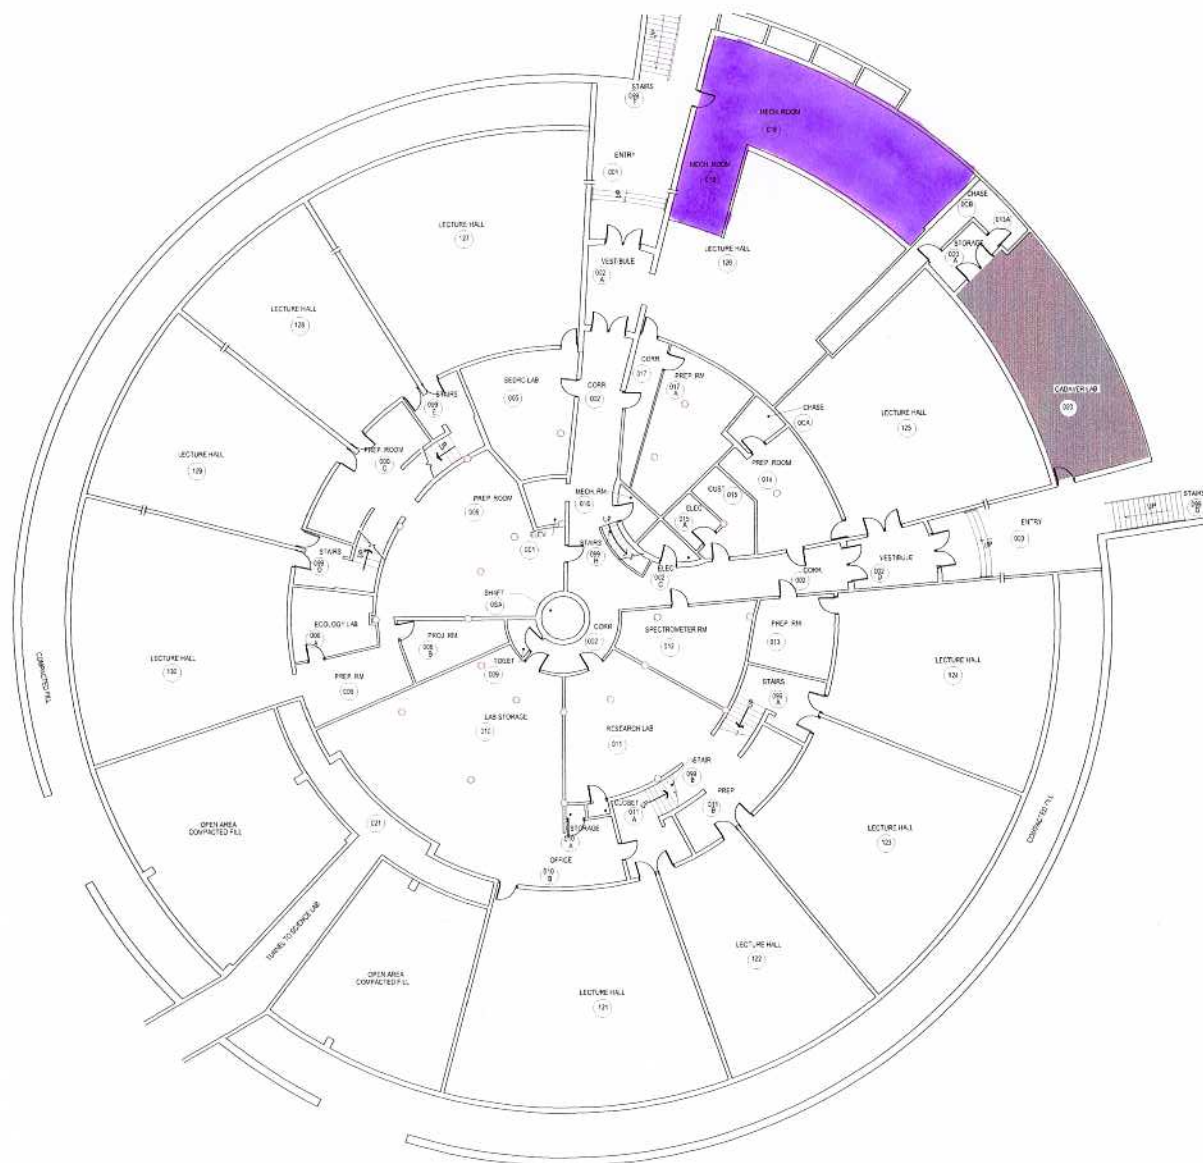

GROUND FLOOR DEMO PLAN

0 2 4 8
SCALE: 3/32" = 1'-0"




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TEXTURED CEILING MATERIAL
TCM



FLOOR TILE & MASTIC



FIRST FLOOR PLAN

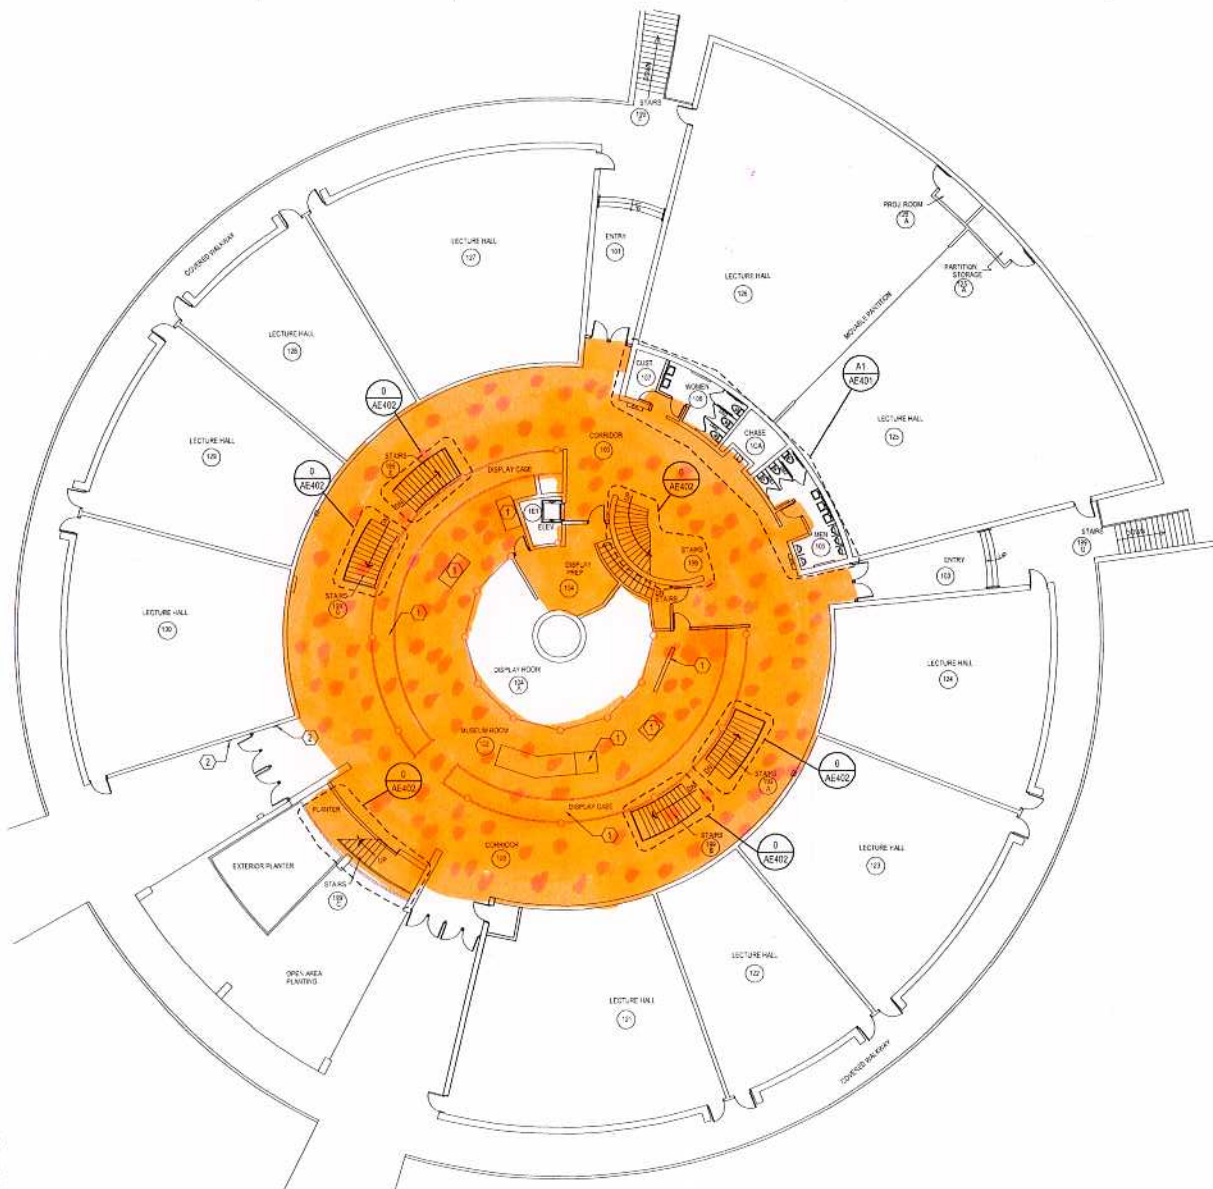0 2 4 8
SCALE: 3/32" = 1'0"

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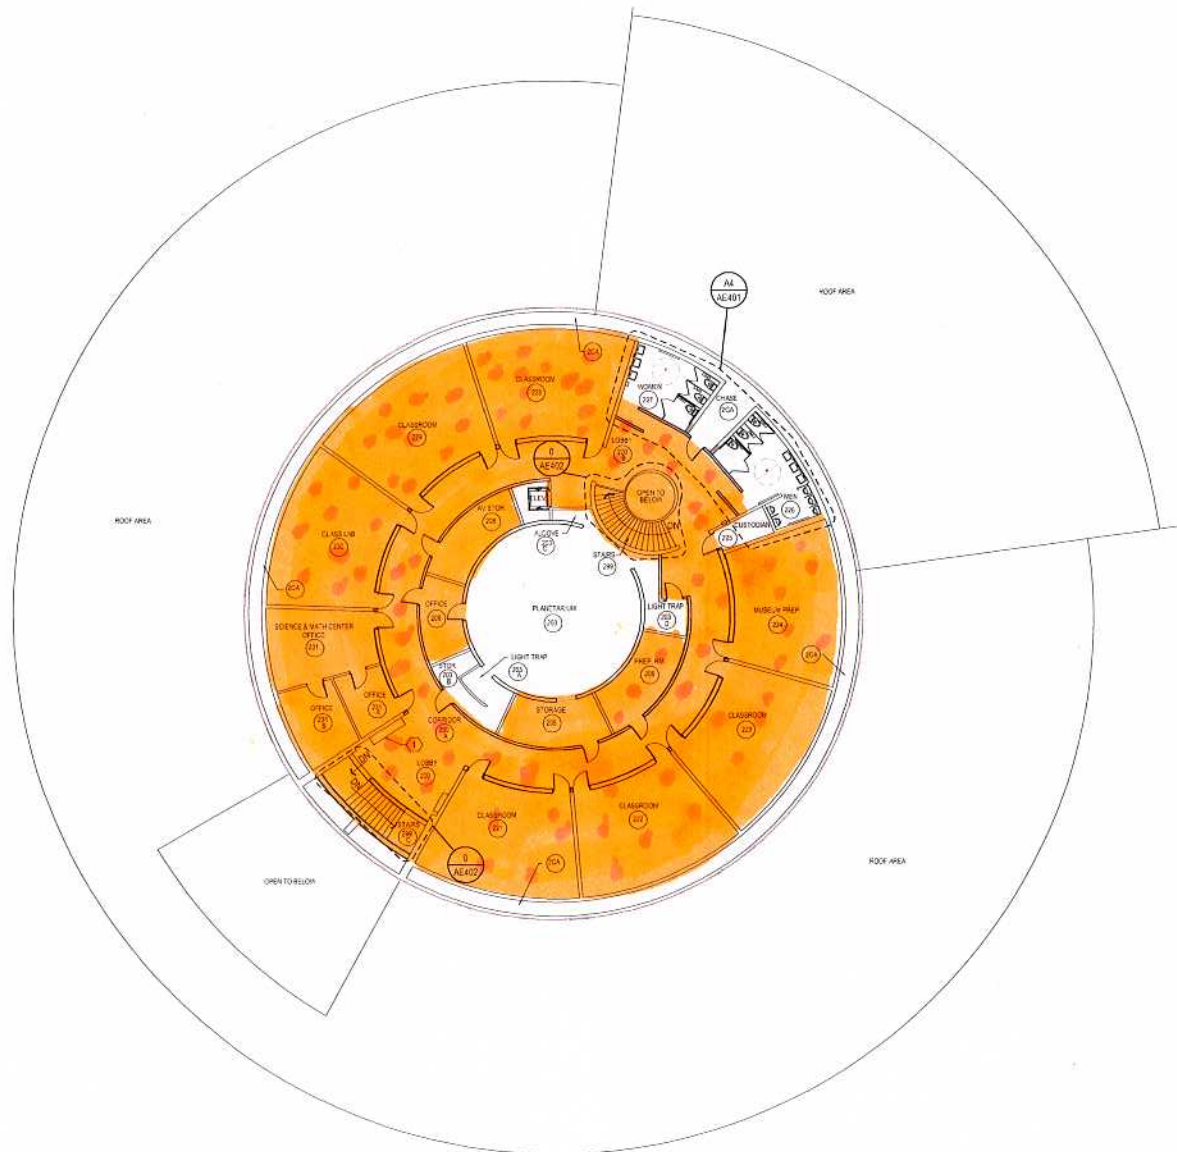


TEXTURED CEILING MATERIAL
TCM


THERMAL SYSTEM INSULATION
TSI JOINTS/FITTINGS (MUDDIED)



FLOOR TILE & MASTIC



SECOND FLOOR PLAN

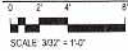

SCALE: 3/32" = 1'-0"




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0 2 4 6 8
SCALE: 3/32" = 1'-0"

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By: R. J. C. 10/18/2005 10:28am
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KEYED NOTES

- 1 REMOVE EXISTING CONDENSING UNIT AND ASSOCIATED PIPING, ETC..
- 2 REMOVE EXISTING HVAC UNIT, DUCTWORK, CONTROLS, LOUVER, PIPING, ETC..
- 3 REMOVE EXISTING GRILLE.
- 4 REMOVE EXISTING DUCT, GRILLE, LOUVER, ETC..
- 5 EXISTING EQUIPMENT, DUCTWORK AND PIPING TO REMAIN SHOWN LIGHT (TYPICAL).

GENERAL NOTES

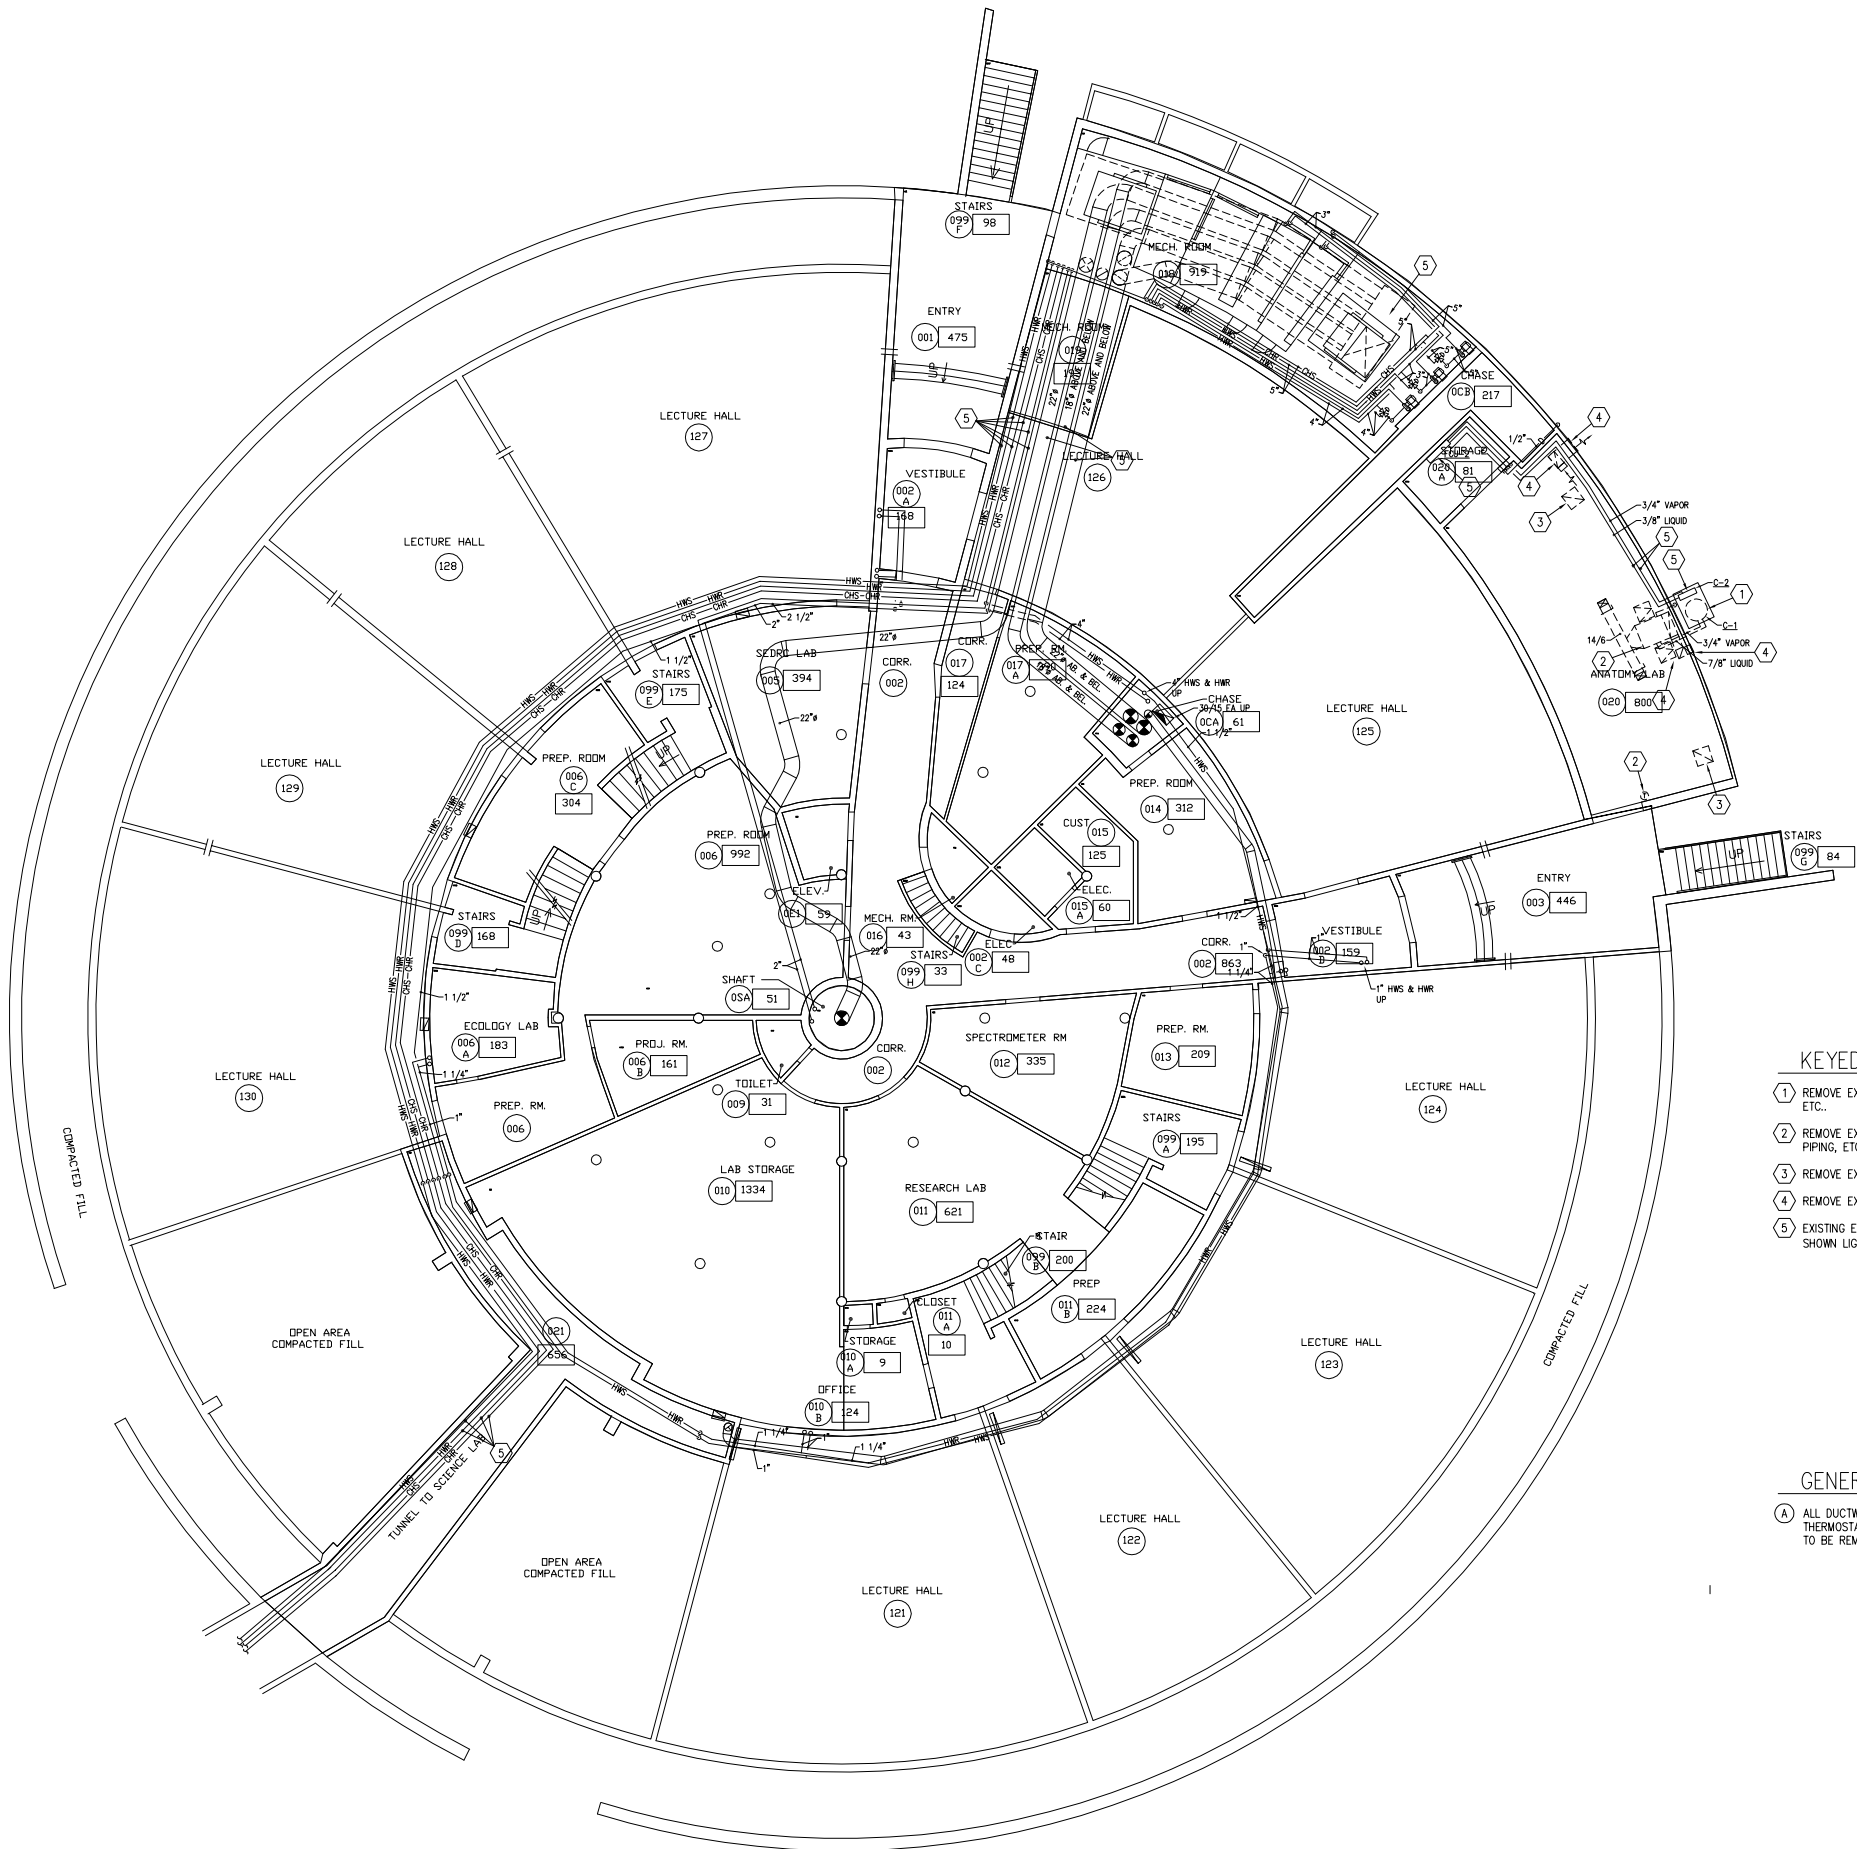- A ALL DUCTWORK, EQUIPMENT, CONTROLS, DIFFUSER, THERMOSTAT, GRILLES, ETC. SHOWN DASHED AND DARK ARE TO BE REMOVED UNLESS OTHERWISE NOTED.

GROUND FLOOR MECHANICAL DEMOLITION PLAN

SCALE: 3/32" = 1'-0"

6' 0' 4' 8' 12' 16' 24'



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GROUND FLOOR MECHANICAL DEMOLITION PLAN


DEMOLITION SET
DATE 03/24/06

SHEET NUMBER

DMH100

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By: R. J. C. / 10/10/2006 / 10:10am
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KEYED NOTES


- 1 REMOVE EXISTING CEILING GRILLE (TYP.).
- 2 DISCONNECT EXISTING VAV BOX FROM HOT WATER SUPPLY AND RETURN PIPING, DUCT AND CONTROLS AND REMOVE (TYP.).
- 3 REMOVE EXISTING EXHAUST FAN.
- 4 REMOVE EXISTING EXHAUST GRILLE.
- 5 REMOVE EXISTING CONVECTOR CONTROLS AND PIPING AS SHOWN.
- 6 REMOVE EXISTING CONTROL.
- 7 REMOVE EXISTING SIDEWALL DIFFUSERS.

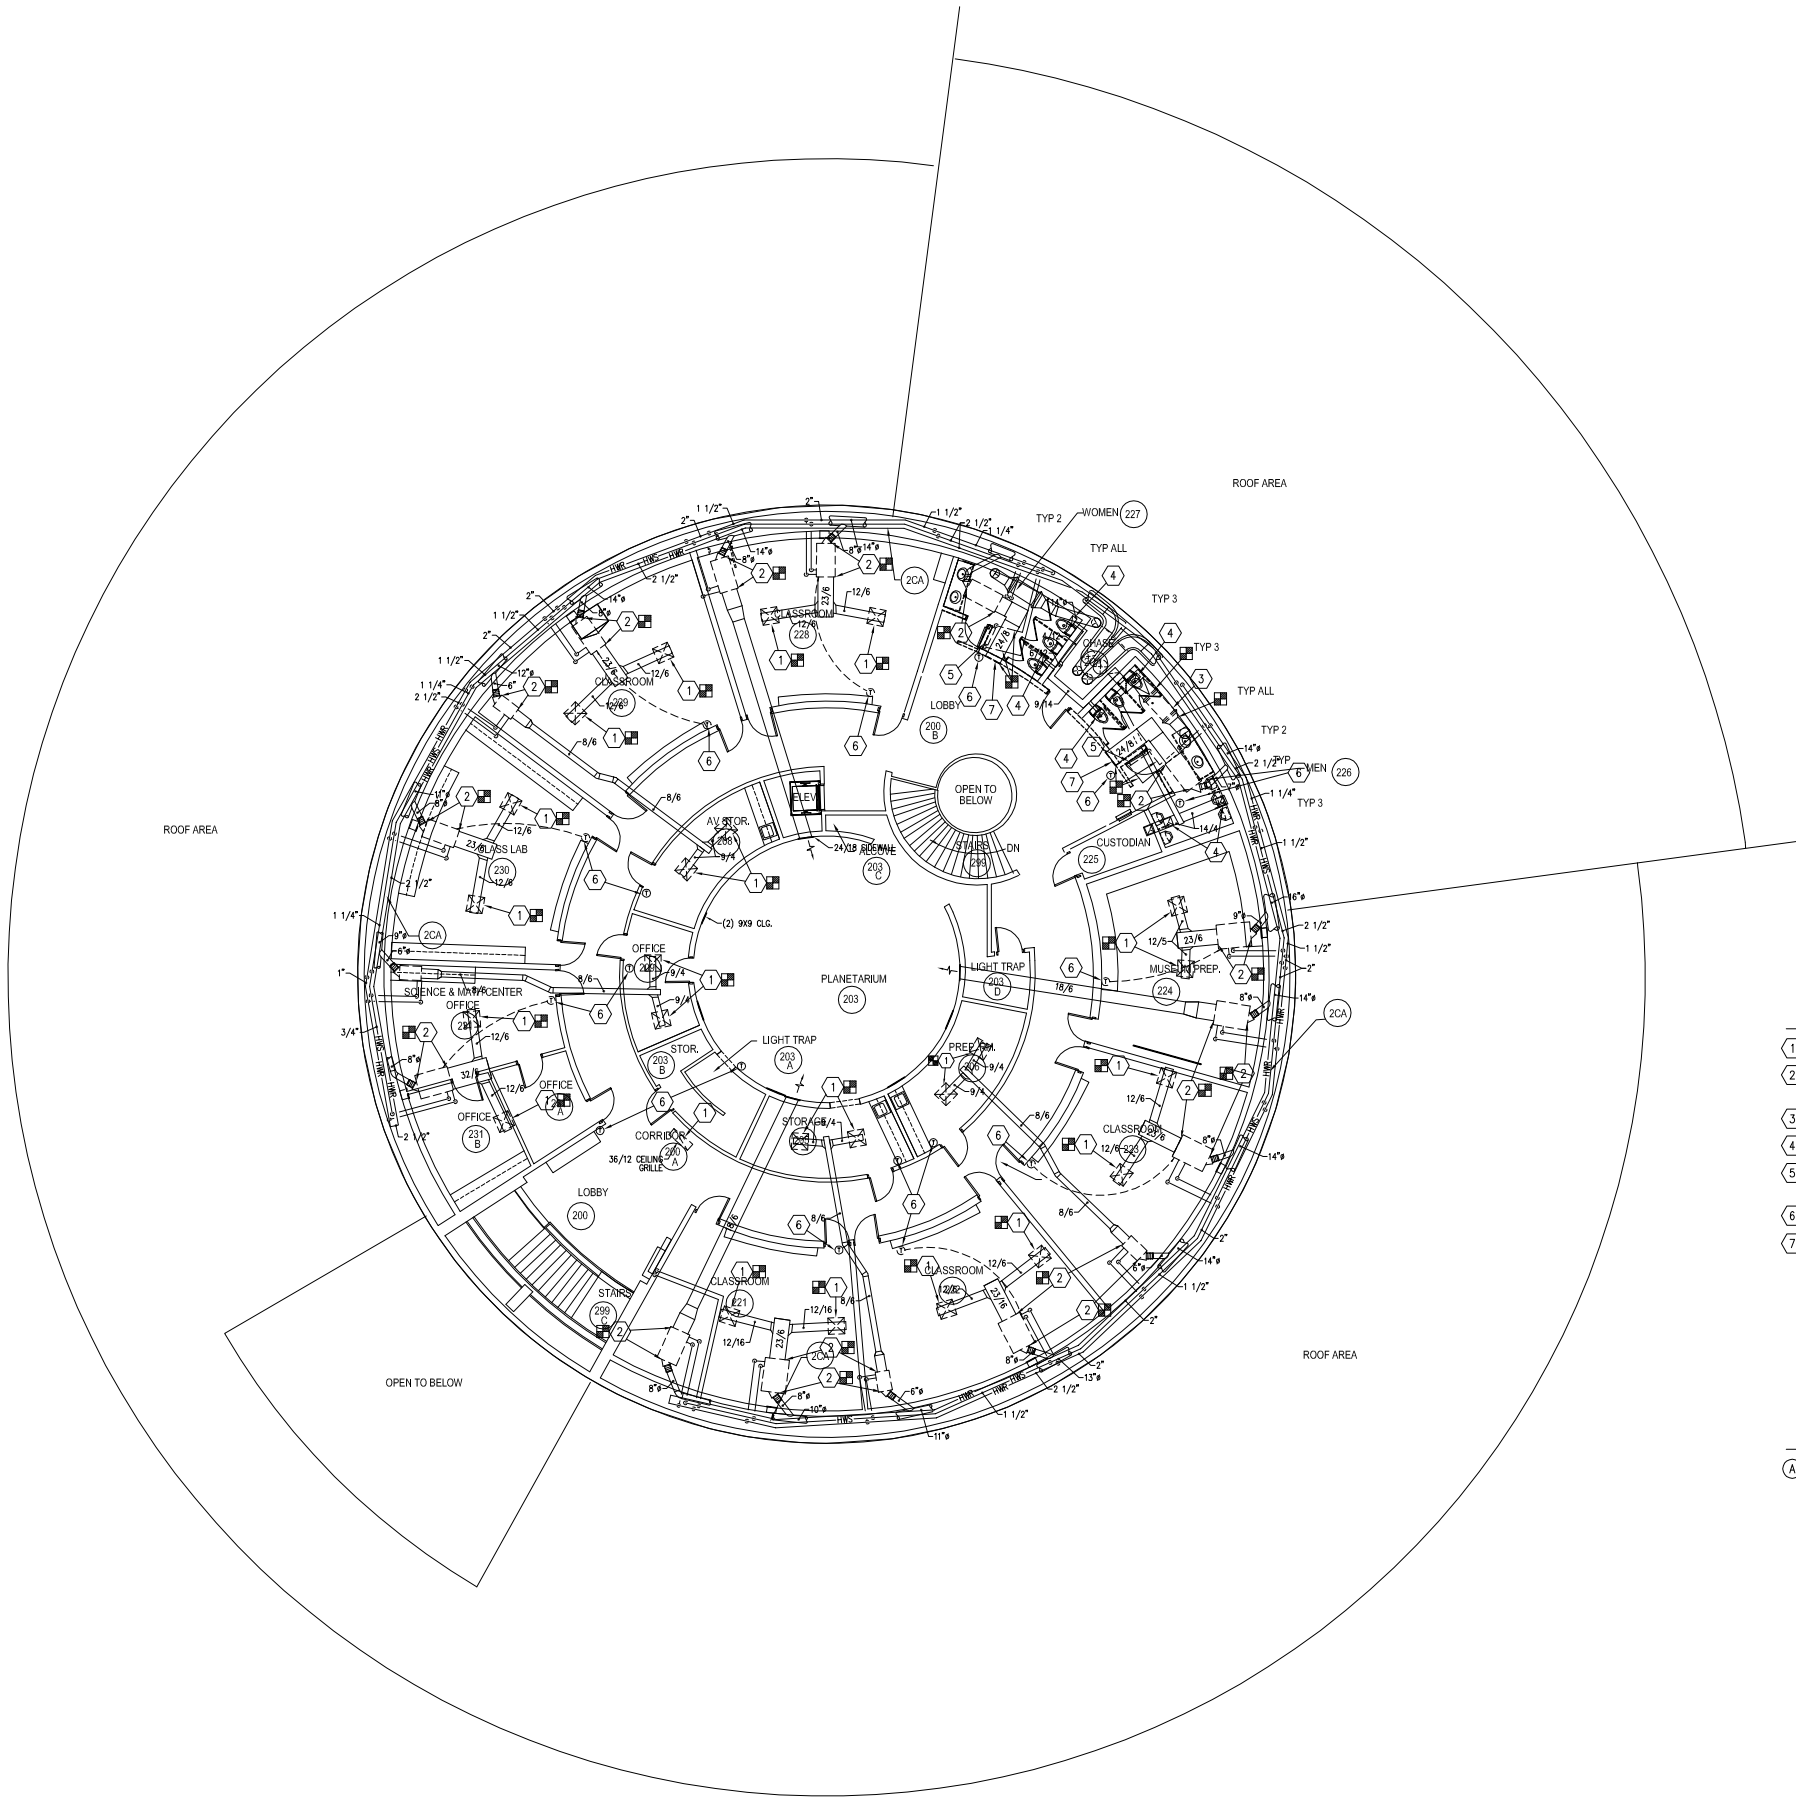GENERAL NOTES

- A ALL DUCTWORK, EQUIPMENT, CONTROLS, DIFFUSER, THERMOSTAT, GRILLES, ETC. SHOWN DASHED AND DARK ARE TO BE REMOVED UNLESS OTHERWISE NOTED.

SECOND FLOOR MECHANICAL DEMOLITION PLAN

SCALE: 3/32" = 1'-0"

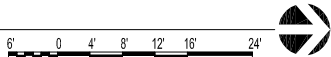

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SECOND FLOOR MECHANICAL DEMOLITION PLAN


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By: RJS, L. Mar 16, 2006 - 10:58am
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11 Drawings\Demolition\New Floor\DPL 101.dwg



FIRST FLOOR PLUMBING DEMOLITION PLAN
SCALE: 3/32" = 1'-0"
1

KEYED NOTES
1 REMOVE PLUMBING FIXTURE AND DISCONNECT WATER, VENT AND SEWAGE CONNECTIONS. PROTECT PIPING FOR FUTURE CONNECTION.

GENERAL NOTES
A ALL EXISTING PLUMBING FIXTURES ARE TO BE REPLACED IN ORIGINAL LOCATIONS.
B OWNER TO SALVAGE ALL FLUSH VALES AND ELECTRIC WATER COOLERS BEFORE DEMOLITION BEGINS.

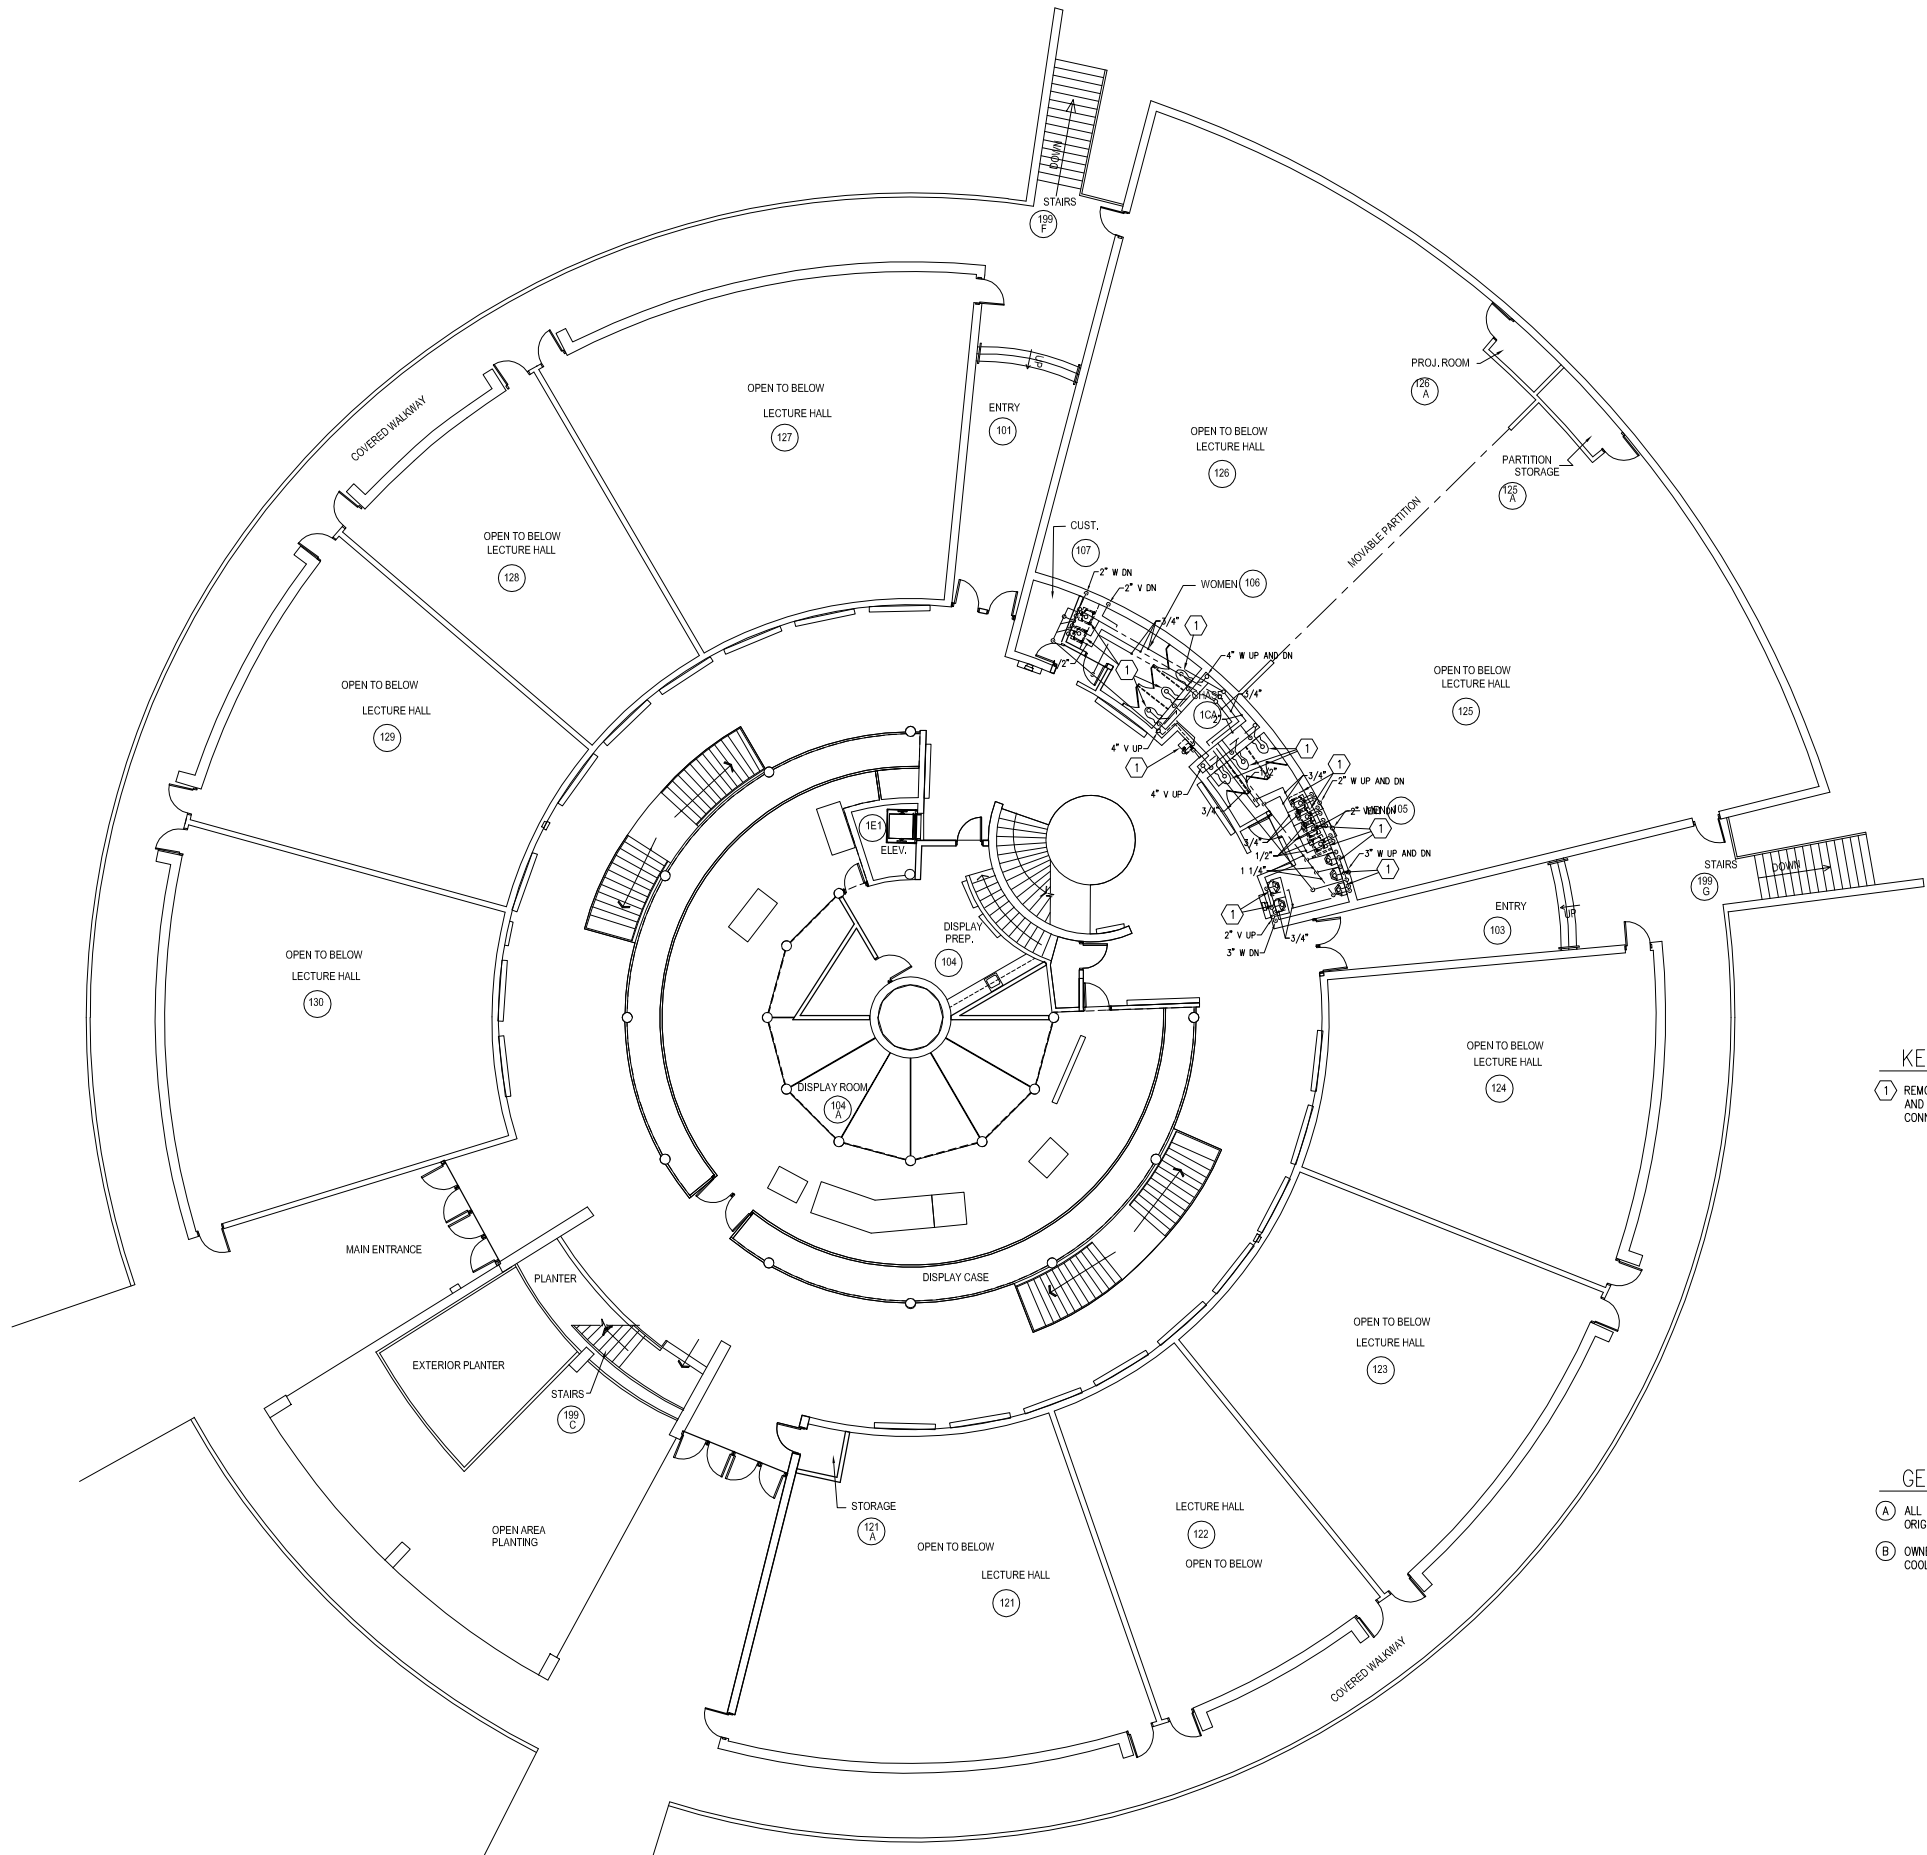

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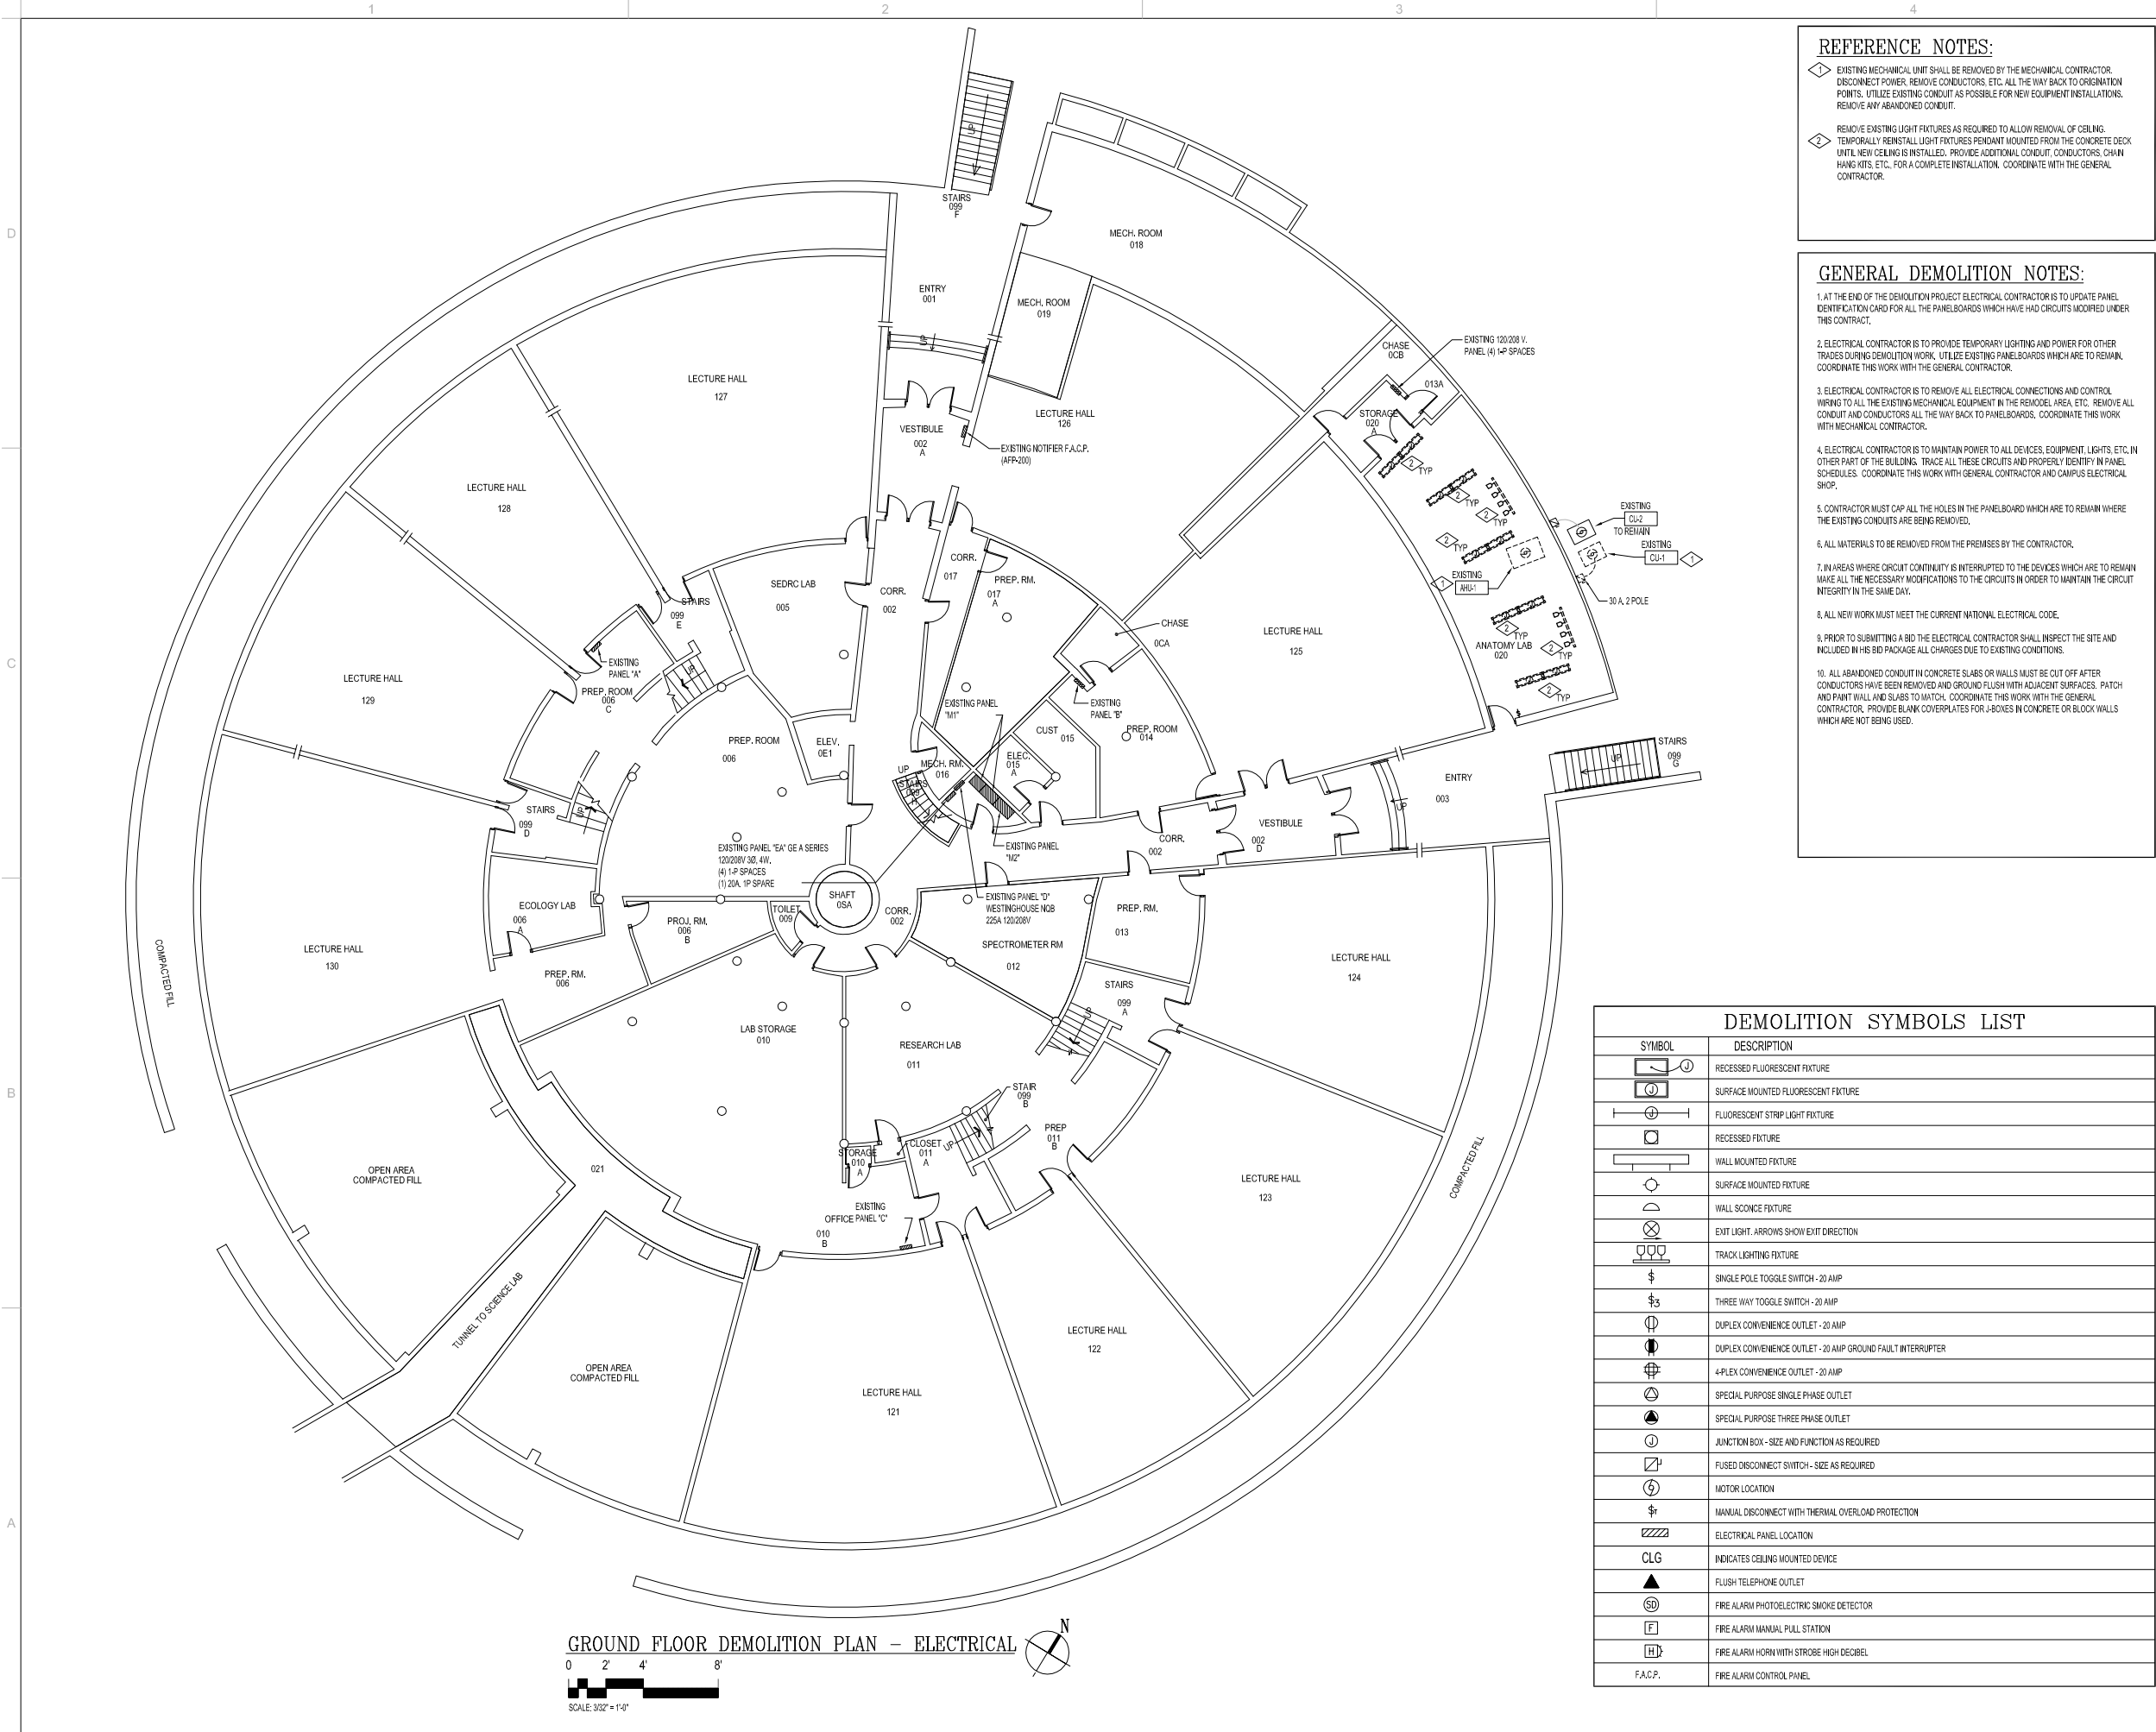
**FIRST FLOOR
PLUMBING
DEMOLITION PLAN**

DEMOLITION SET
DATE 03/24/06

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- REFERENCE NOTES:**
- EXISTING MECHANICAL UNIT SHALL BE REMOVED BY THE MECHANICAL CONTRACTOR. DISCONNECT POWER, REMOVE CONDUCTORS, ETC. ALL THE WAY BACK TO ORIGINATION POINTS. UTILIZE EXISTING CONDUIT AS POSSIBLE FOR NEW EQUIPMENT INSTALLATIONS. REMOVE ANY ABANDONED CONDUIT.
 - REMOVE EXISTING LIGHT FIXTURES AS REQUIRED TO ALLOW REMOVAL OF CEILING. TEMPORARILY REINSTALL LIGHT FIXTURES PENDANT MOUNTED FROM THE CONCRETE DECK UNTIL NEW CEILING IS INSTALLED. PROVIDE ADDITIONAL CONDUIT, CONDUCTORS, CHAIN HANG KITS, ETC., FOR A COMPLETE INSTALLATION. COORDINATE WITH THE GENERAL CONTRACTOR.

- GENERAL DEMOLITION NOTES:**
- AT THE END OF THE DEMOLITION PROJECT ELECTRICAL CONTRACTOR IS TO UPDATE PANEL IDENTIFICATION CARD FOR ALL THE PANELBOARDS WHICH HAVE HAD CIRCUITS MODIFIED UNDER THIS CONTRACT.
 - ELECTRICAL CONTRACTOR IS TO PROVIDE TEMPORARY LIGHTING AND POWER FOR OTHER TRADES DURING DEMOLITION WORK. UTILIZE EXISTING PANELBOARDS WHICH ARE TO REMAIN. COORDINATE THIS WORK WITH THE GENERAL CONTRACTOR.
 - ELECTRICAL CONTRACTOR IS TO REMOVE ALL ELECTRICAL CONNECTIONS AND CONTROL WIRING TO ALL THE EXISTING MECHANICAL EQUIPMENT IN THE REMODEL AREA, ETC. REMOVE ALL CONDUIT AND CONDUCTORS ALL THE WAY BACK TO PANELBOARDS. COORDINATE THIS WORK WITH MECHANICAL CONTRACTOR.
 - ELECTRICAL CONTRACTOR IS TO MAINTAIN POWER TO ALL DEVICES, EQUIPMENT, LIGHTS, ETC. IN OTHER PART OF THE BUILDING. TRACE ALL THESE CIRCUITS AND PROPERLY IDENTIFY IN PANEL SCHEDULES. COORDINATE THIS WORK WITH GENERAL CONTRACTOR AND CAMPUS ELECTRICAL SHOP.
 - CONTRACTOR MUST CAP ALL THE HOLES IN THE PANELBOARD WHICH ARE TO REMAIN WHERE THE EXISTING CONDUITS ARE BEING REMOVED.
 - ALL MATERIALS TO BE REMOVED FROM THE PREMISES BY THE CONTRACTOR.
 - IN AREAS WHERE CIRCUIT CONTINUITY IS INTERRUPTED TO THE DEVICES WHICH ARE TO REMAIN MAKE ALL THE NECESSARY MODIFICATIONS TO THE CIRCUITS IN ORDER TO MAINTAIN THE CIRCUIT INTEGRITY IN THE SAME DAY.
 - ALL NEW WORK MUST MEET THE CURRENT NATIONAL ELECTRICAL CODE.
 - PRIOR TO SUBMITTING A BID THE ELECTRICAL CONTRACTOR SHALL INSPECT THE SITE AND INCLUDED IN HIS BID PACKAGE ALL CHARGES DUE TO EXISTING CONDITIONS.
 - ALL ABANDONED CONDUIT IN CONCRETE SLABS OR WALLS MUST BE CUT OFF AFTER CONDUCTORS HAVE BEEN REMOVED AND GROUND FLUSH WITH ADJACENT SURFACES. PATCH AND PAINT WALL AND SLABS TO MATCH. COORDINATE THIS WORK WITH THE GENERAL CONTRACTOR. PROVIDE BLANK COVERPLATES FOR J-BOXES IN CONCRETE OR BLOCK WALLS WHICH ARE NOT BEING USED.


DEMOLITION SYMBOLS LIST	
SYMBOL	DESCRIPTION
	RECESSED FLUORESCENT FIXTURE
	SURFACE MOUNTED FLUORESCENT FIXTURE
	FLUORESCENT STRIP LIGHT FIXTURE
	RECESSED FIXTURE
	WALL MOUNTED FIXTURE
	SURFACE MOUNTED FIXTURE
	WALL SCONCE FIXTURE
	EXIT LIGHT, ARROWS SHOW EXIT DIRECTION
	TRACK LIGHTING FIXTURE
	SINGLE POLE TOGGLE SWITCH - 20 AMP
	THREE WAY TOGGLE SWITCH - 20 AMP
	DUPLEX CONVENIENCE OUTLET - 20 AMP
	DUPLEX CONVENIENCE OUTLET - 20 AMP GROUND FAULT INTERRUPTER
	4-PLEX CONVENIENCE OUTLET - 20 AMP
	SPECIAL PURPOSE SINGLE PHASE OUTLET
	SPECIAL PURPOSE THREE PHASE OUTLET
	JUNCTION BOX - SIZE AND FUNCTION AS REQUIRED
	FUSED DISCONNECT SWITCH - SIZE AS REQUIRED
	MOTOR LOCATION
	MANUAL DISCONNECT WITH THERMAL OVERLOAD PROTECTION
	ELECTRICAL PANEL LOCATION
	INDICATES CEILING MOUNTED DEVICE
	FLUSH TELEPHONE OUTLET
	FIRE ALARM PHOTOELECTRIC SMOKE DETECTOR
	FIRE ALARM MANUAL PULL STATION
	FIRE ALARM HORN WITH STROBE HIGH DECIBEL
	FIRE ALARM CONTROL PANEL

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MHTN PROJECT NO. 2005605 ECE PROJECT NO. 3021
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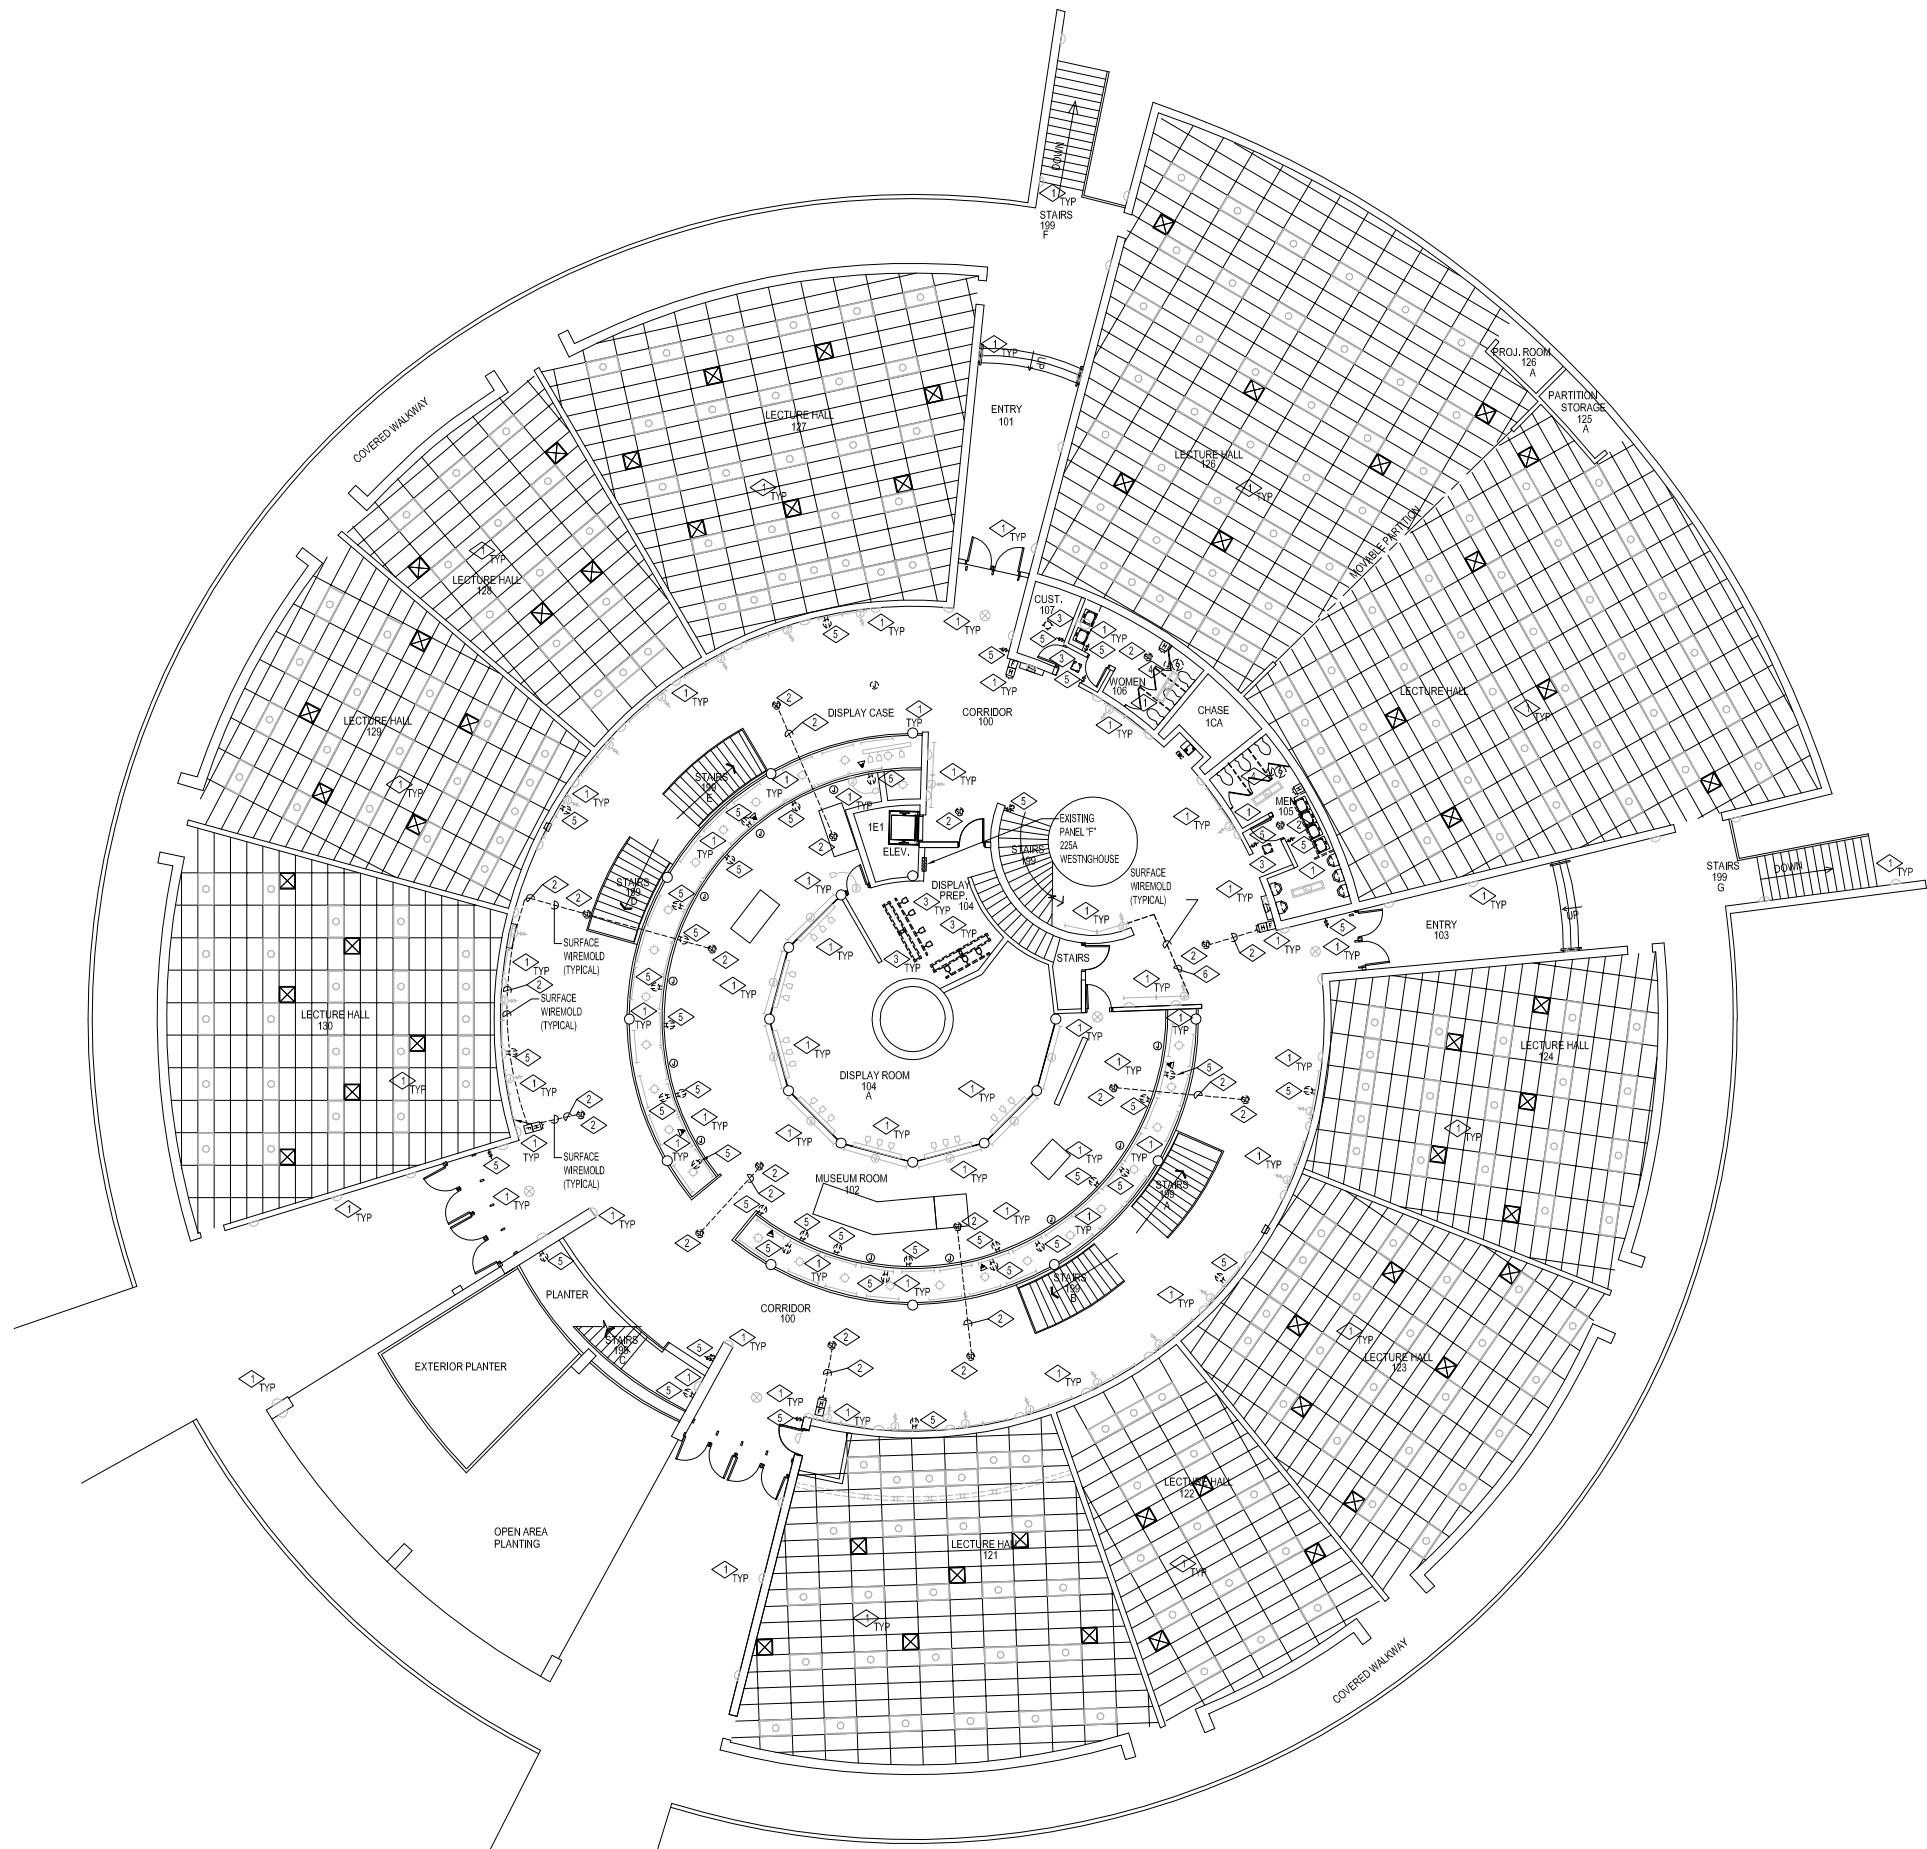
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**GROUND FLOOR
DEMOLITION PLAN
ELECTRICAL**

DEMO & ABATEMENT SET

SHEET NUMBER

DEE100

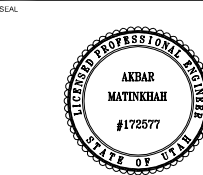

- REFERENCE NOTES:**
- 1. EXISTING DEVICES SHALL REMAIN. MAKE ANY MODIFICATIONS REQUIRED TO MAINTAIN CIRCUIT INTEGRITY.
 - 2. REMOVE THE EXISTING FIRE ALARM DEVICES AND ASSOCIATED J-BOXES, CONDUIT, CONDUCTORS, ETC., FROM THE CEILING TO ALLOW ABATEMENT. COORDINATE THIS WORK WITH MOUNTAIN ALARM. PORTIONS OF THIS BUILDING SHALL REMAIN OCCUPIED DURING THIS PROJECT. FIRE ALARM SYSTEM IN THE OCCUPIED SPACE SHALL REMAIN OPERATIONAL. REMOVE CONDUIT AND CONDUCTORS AS REQUIRED BACK TO NEAREST DEVICE THAT SHALL REMAIN. PROTECT AND STORE EXISTING DEVICES FOR NEW INSTALLATION.
 - 3. REMOVE THE EXISTING LIGHT FIXTURES INDICATED. REMOVE CONDUCTORS BACK TO ORIGIN POINT. UTILIZE EXISTING CONDUIT AND J-BOXES AS POSSIBLE FOR NEW INSTALLATION. REMOVE ANY ABANDONED CONDUIT.
 - 4. EXISTING EXHAUST FAN SHALL BE REMOVED BY MECHANICAL CONTRACTOR. DISCONNECT POWER AND REMOVE ASSOCIATED CONDUCTORS ALL THE WAY BACK TO POINT OF ORIGIN. UTILIZE EXISTING CONDUIT AS POSSIBLE FOR NEW INSTALLATION. REMOVE ANY ABANDONED CONDUIT.
 - 5. REMOVE THE EXISTING DUPLEX OUTLETS AND LIGHT SWITCHES SHOWN AND REPLACE WITH NEW DEVICES AND COVERPLATES. EXTEND EXISTING CIRCUITS TO THE NEW DEVICES. PROVIDE TYPED CIRCUIT TAG ON NEW COVERPLATE TO INDICATE PANEL AND CIRCUIT.
 - 6. REMOVE THE EXISTING SURFACE RACEWAY TO ALLOW ABATEMENT OF CEILING. REPLACE WITH NEW SURFACE RACEWAY.

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**LIND LECTURE HALL REMODEL
WEBER STATE UNIVERSITY
OGDEN CAMPUS OGDEN, UTAH**
UTAH STATE DIVISION OF
FACILITIES CONSTRUCTION & MANAGEMENT
DFCM PROJECT NO. 04040810



MHTN PROJECT NO. 2005605 ECE PROJECT NO. 3021
DRAWN BY: JHM CHECKED BY: AM

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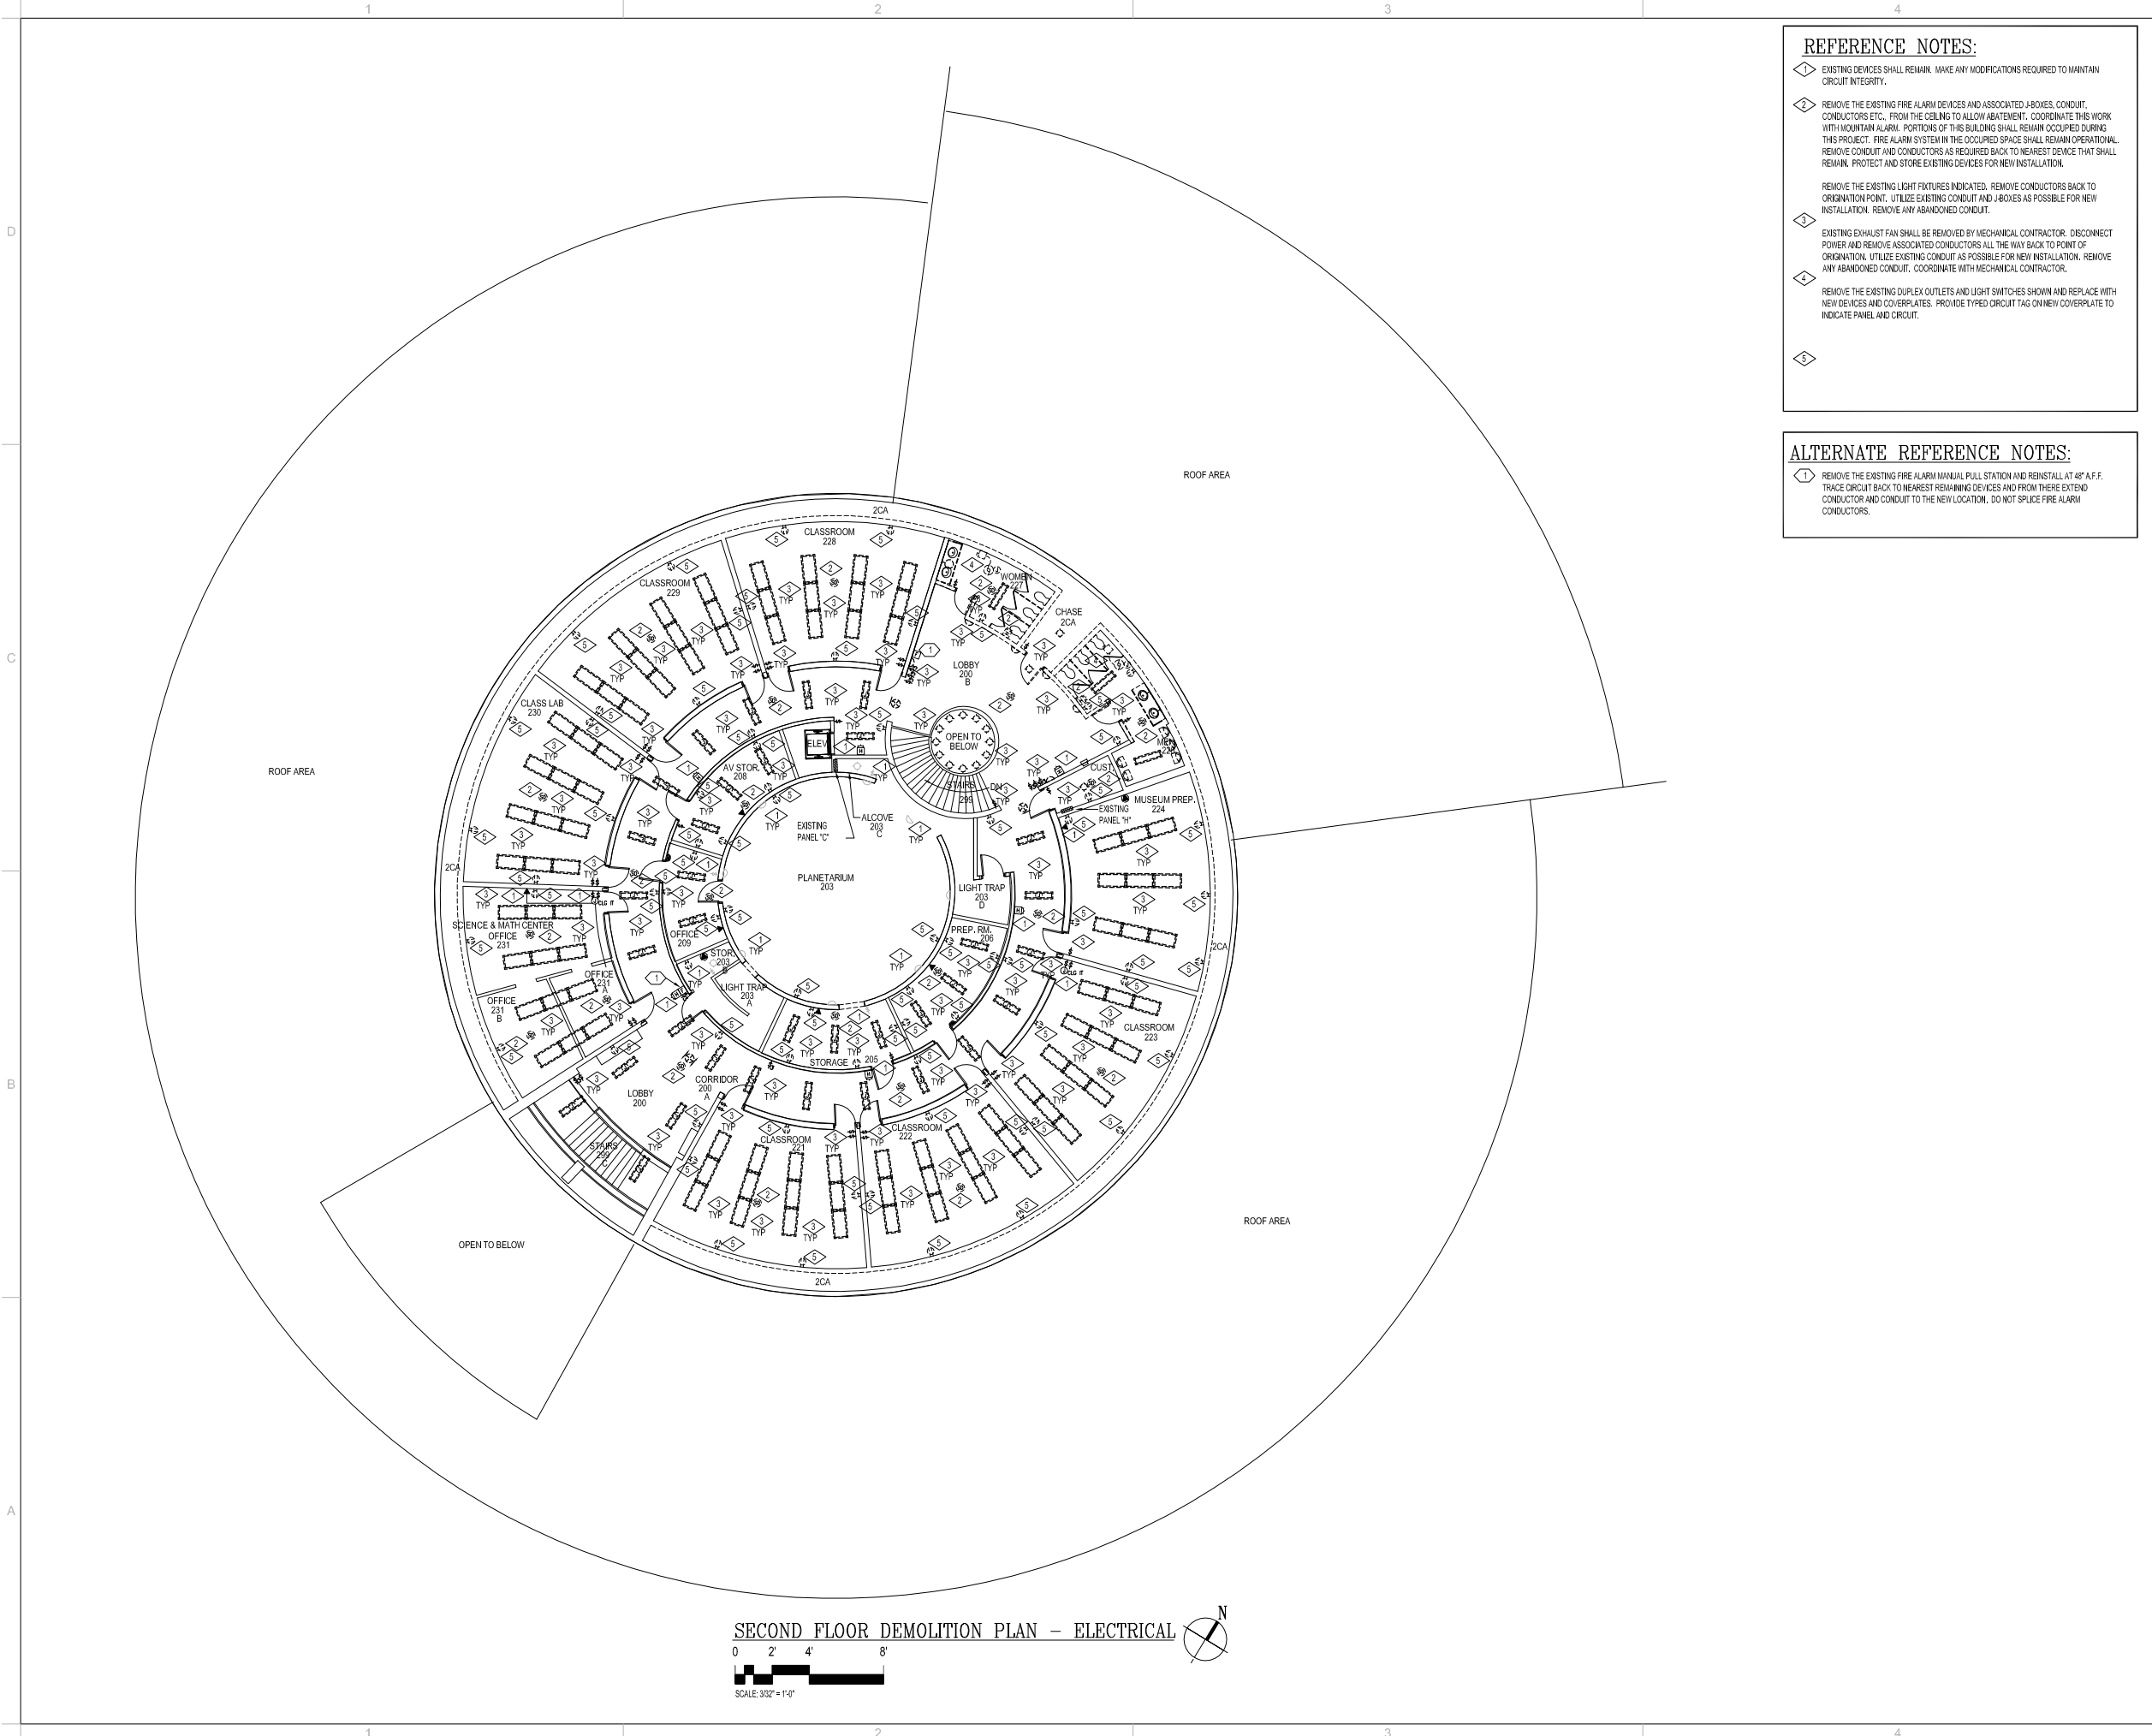
**FIRST FLOOR
DEMOLITION PLAN
ELECTRICAL**

DEMO & ABATEMENT SET

SHEET NUMBER

DEE101

FIRST FLOOR DEMOLITION PLAN - ELECTRICAL
0 2' 4' 8'
SCALE: 3/32" = 1'-0"



- REFERENCE NOTES:**
- 1 EXISTING DEVICES SHALL REMAIN. MAKE ANY MODIFICATIONS REQUIRED TO MAINTAIN CIRCUIT INTEGRITY.
 - 2 REMOVE THE EXISTING FIRE ALARM DEVICES AND ASSOCIATED J-BOXES, CONDUIT, CONDUCTORS ETC., FROM THE CEILING TO ALLOW ABATEMENT. COORDINATE THIS WORK WITH MOUNTAIN ALARM. PORTIONS OF THIS BUILDING SHALL REMAIN OCCUPIED DURING THIS PROJECT. FIRE ALARM SYSTEM IN THE OCCUPIED SPACE SHALL REMAIN OPERATIONAL. REMOVE CONDUIT AND CONDUCTORS AS REQUIRED BACK TO NEAREST DEVICE THAT SHALL REMAIN. PROTECT AND STORE EXISTING DEVICES FOR NEW INSTALLATION.
 - 3 REMOVE THE EXISTING LIGHT FIXTURES INDICATED. REMOVE CONDUCTORS BACK TO ORIGINATION POINT. UTILIZE EXISTING CONDUIT AND J-BOXES AS POSSIBLE FOR NEW INSTALLATION. REMOVE ANY ABANDONED CONDUIT.
 - 4 EXISTING EXHAUST FAN SHALL BE REMOVED BY MECHANICAL CONTRACTOR. DISCONNECT POWER AND REMOVE ASSOCIATED CONDUCTORS ALL THE WAY BACK TO POINT OF ORIGINATION. UTILIZE EXISTING CONDUIT AS POSSIBLE FOR NEW INSTALLATION. REMOVE ANY ABANDONED CONDUIT. COORDINATE WITH MECHANICAL CONTRACTOR.
 - 5 REMOVE THE EXISTING DUPLEX OUTLETS AND LIGHT SWITCHES SHOWN AND REPLACE WITH NEW DEVICES AND COVERPLATES. PROVIDE TYPED CIRCUIT TAG ON NEW COVERPLATE TO INDICATE PANEL AND CIRCUIT.

- ALTERNATE REFERENCE NOTES:**
- 1 REMOVE THE EXISTING FIRE ALARM MANUAL PULL STATION AND REINSTALL AT 48" A.F.F. TRACE CIRCUIT BACK TO NEAREST REMAINING DEVICES AND FROM THERE EXTEND CONDUCTOR AND CONDUIT TO THE NEW LOCATION. DO NOT SPLICE FIRE ALARM CONDUCTORS.

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WEBER STATE UNIVERSITY
OGDEN CAMPUS OGDEN, UTAH**

UTAH STATE DIVISION OF
FACILITIES CONSTRUCTION & MANAGEMENT
DFCM PROJECT NO. 04040810

SEAL

AKBAR MATINKHAH
#172577
LICENSED PROFESSIONAL ELECTRICAL ENGINEER
STATE OF UTAH

MHTN PROJECT NO. 2005605 ECE PROJECT NO. 3021
DRAWN BY: JHM CHECKED BY: AM

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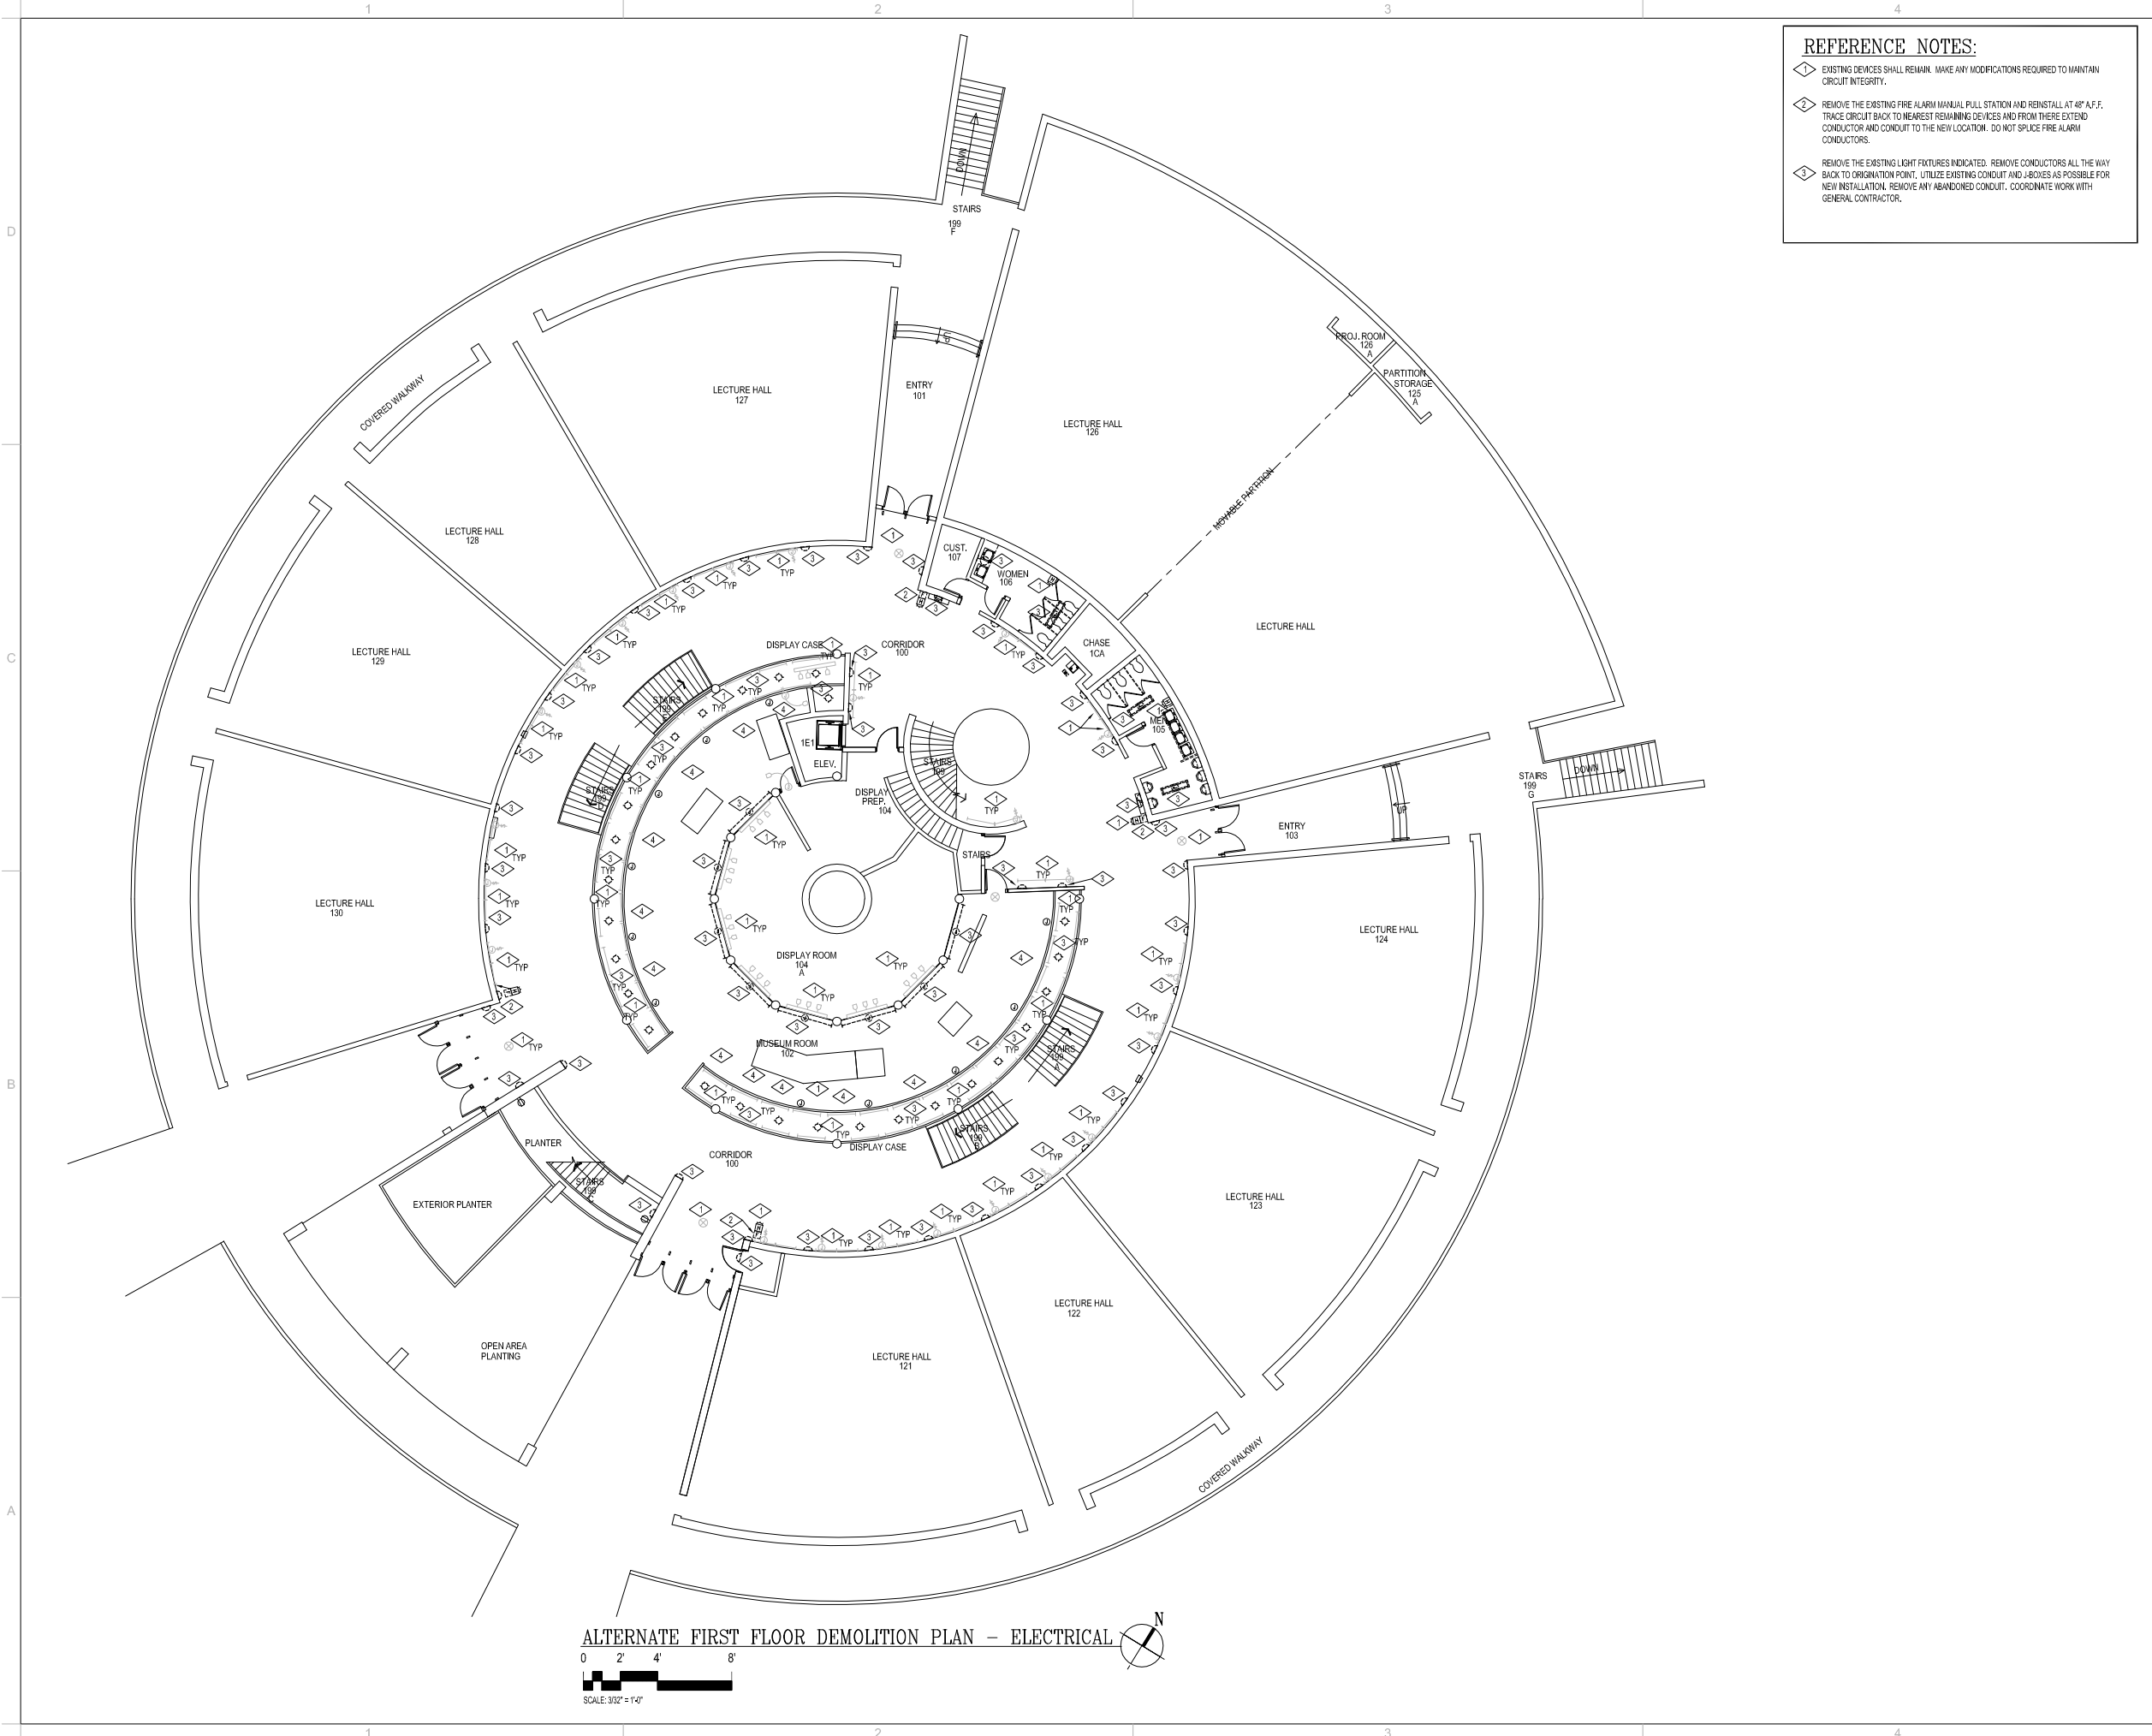
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SECOND FLOOR DEMOLITION PLAN ELECTRICAL

DEMO & ABATEMENT SET

SHEET NUMBER

DEE102



- REFERENCE NOTES:**
- 1 EXISTING DEVICES SHALL REMAIN. MAKE ANY MODIFICATIONS REQUIRED TO MAINTAIN CIRCUIT INTEGRITY.
 - 2 REMOVE THE EXISTING FIRE ALARM MANUAL PULL STATION AND REINSTALL AT 48" A.F.F. TRACE CIRCUIT BACK TO NEAREST REMAINING DEVICES AND FROM THERE EXTEND CONDUCTOR AND CONDUIT TO THE NEW LOCATION. DO NOT SPLICE FIRE ALARM CONDUCTORS.
 - 3 REMOVE THE EXISTING LIGHT FIXTURES INDICATED. REMOVE CONDUCTORS ALL THE WAY BACK TO ORIGINATION POINT. UTILIZE EXISTING CONDUIT AND J-BOXES AS POSSIBLE FOR NEW INSTALLATION. REMOVE ANY ABANDONED CONDUIT. COORDINATE WORK WITH GENERAL CONTRACTOR.

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DFCM PROJECT NO. 04040810



MHTN PROJECT NO. 2005605 ECE PROJECT NO. 3021
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**ALT. FIRST FLOOR
DEMOLITION PLAN
ELECTRICAL**

DEMO & ABATEMENT SET

SHEET NUMBER

DEE101-ALT